THE HIGHEST CRAFT TENANT IMPROVEMENT BUILDING-D, E & F **571 CRANE STREET** LAKE ELSINORE, CA 92530

ABBREVIATIONS

AC	ASPHALT CONCRETÉ	NTS	NOT TO SCALE
ACT	ACOUSTICAL CEILING TILE	O C	ON CENTER
AFF	ABOVE FINISH FLOOR	O D	OUTSIDE DIAMETER
ALUM	ALUMINUM	O.F.C.I	OWNER FURNISHED CONTRACTOR INSTALL
BLKG	BLOCKING	OFD	OVERFLOW DRAIN
BM	BEAM	OPP	OPPOSITE
8.0	BOTTOM OF	0.8	OVERFLOW SCUPPER
BUR	BUILT UP ROOF	OPNG	OPENING
CC	CENTER TO CENTER	OTO	OUT TO OUT
CJ	CONTROL JOINT	OVHD	OVERHÉAD
CL	CENTER LINE	P.L	PROPERTY LINE
CLR	CLEARANCE	PLAM	PLASTIC LAMINATE
CONC	CONCRETE	PLYWD	PLYWOOD
COL	COLUMN	POC	POINT OF CONNECTION
CT	CERAMIC TILE	RAD	RADIUS
CW	COLD WATER LINE	(R)	RELOCATE, UNO
DIA	DIAMETER	RCP	REFLECTED CEILING PLAN
DIM.	DIMENSION	R D	ROOF DRAIN
DS	DOWNSPOUT	R I	ROUGH IN
081	DOUBLE	RIC	ROUGH IN AND CONNECT
(E) E.J	EXISTING EXPANSION JOINT	RO	ROUGH OPENING
ELEV	ELEVATION SOINT	s c	SOLID CORE
EQ	EQUAL	SF	SQUARE FEET
EXT	EXTERIOR	SHT	SHEET
FD	FLOOR DRAIN	SIM	SIMILAR
FIN	FINISH	SPEC	SPECIFICATIONS
FG	FINISH GRADE	SERVSINK	SERVICE SINK STAINLESS STEEL
FLR	FLOOR	ST STL	SANITARY SEWER
FOS	FACE OF STUD	STR	STRUCTURAL
FINS	FINISH SURFACE	SUSP	SUSPENDED
FRT	FIRE RESISTANT TREATED	T.B.D	TO BE DECIDED
FTG	FOOTING	TOC	TOP OF CURB
FSM	FIRE SPRINKLER MAIN	TOE	TOP OF EAVE
FV	FIELD VERIFY	TJ	TOOLED JOINT
GA	GAUGE	TOM	TOP OF MASONRY
GALV	GALVANIZED	TOP	TOP OF PANEL
GC	GENERAL CONTRACTOR	T O PAR	TOP OF PARAPET
GLS	GLASS	TOR	TOP OF RIDGE
GR	GRADE	TOS	STOP OF STEEL
GYP BD	GYPSUM BOARD	TOW	TOP OF WALL
HT	HEIGHT	T O SW	TOP OF SCREEN WALL
H.M	HOLLOW METAL	TOSF	TOP OF STEEL FRAMING
I D	INSIDE DIAMETER	TS	TUBE STEEL
JT	JOINT	TYP	TYPICAL
MEP	MECH., ELEC & PLUMB	UNO	UNLESS NOTED OTHERWISE
MFD	MANUFACTURED	VAR	VARIES
MFR	MANUFACTURER	VCT	VINYL COMPOSITION TILE
M O	MASONRY OPENING	VEST	VESTIBULE
MTD	MOUNTED	VIF	VERIFY IN FIELD
MTL	METAL	WC	WATER CLOSET
NC	NO CEILING	WD	WOOD
NIC	NOT IN CONTRACT	IAI LI	MATER HEATER

VICINITY MAP





14. DO NOT SCALE DRAYINGS, WRITTEN DIMENSIONS GOVERN. IN CASE OF CONFLICT CONSULT THE ARCHITECT INMEDIATELY IN WRITING, LARGE SCALE DRAYINGS HAVE PRECEDENCE OVER SMALL SCALE

15. PARTITIONS/WALLS ARE DIMENSIONED FROM FACE OF STUD TO FACE OF STUD, UNLESS OTHERWISE NOTED. MAINTAIN DIMENSIONS MARKED "CLEAR", ALLOW FOR THICKNESS OF FINISHES AS INDICATED.

- 17. GENERAL CONTRACTOR SHALL PROVIDE ALL NECESSARY BLOCKING IN WALLS FOR SUPPORT OF ALL EQUIPMENT, SHELVING, ACCESSORIES AND OTHER DEVICES REQUIRED

18. COORDINATE AND PROVIDE BLOCKING FOR MILLIYORK AND ITEMS ATTACHED OR MOUNTED TO WALLS OR CELLINGS.

20. UNDERCUT DOORS TO CLEAR TOP OF FLOOR FINISHES BY 1/4 INCH

23. MATERIALS EXPOSED WITHIN PLENUMS ARE REQUIRED TO BE NON COMBUSTIBLE OR SHALL HAVE A FLAME SPREAD RIDEX OF NOT MORE THAN 25 AND A SMORE-DEVELOPMENT INDEX OF NOT MORE THAN 25 AND A SMORE-DEVELOPMENT INDEX OF NOT MORE THAN 50 AS DETERMINED IN ACCORDANCE WITH ASTIM 6 84

PROJECT CONTACT INFORMATION

OWNER SOUTHERN CALIFORNIA INVESTORS 43414 BUSINESS PARK DRIVE TEMECULA, CA 92590 COMACUL BOB ERDTSIECK 951-232-1121	TENANT THE HIGHEST CRAFT 571-F CRAME STREET LAKE ELSINORE, CA 92530 CONTACT SEBASTIAN BRINKMANN 951-913-4994	
ARCHITECT ANDREW CARLOS, ARCHITECT, AIA 3227 ADAMS STREET CARLSBAD, CA 92006 CONTACT, ANDREW CARLOS 760,579,3996		

PROJECT DATA

THE APPLICABLE CODE FOR THIS PROJECT IS THE 2016 TRIENNIAL EDITION OF THE CALIFORNIA CODE OF REGULATIONS (CCR), TITLE 24, (WHICH IS COMPOSED OF 12 PARTS) REFERRED TO AS THE CALIFORNIA BUILDING STANDARDS CODE, AND ADOPTS THE FOLLOWING MODEL CODES WITH CALIFORNIA AMENDMENTS

2016 CALIFORNIA ELECTRICAL CODE 2016 CALIFORNIA ENERGY CODE 2016 CALIFORNIA FIRE CODE 2016 CALIFORNIA GREEN BUILDING STANDARDS CODE

BUILDING DATA

571-D: 6,893 GSF

571-F 4 033 GSF

571-F 4 033 GS

BUILDING AREA CONSTRUCTION TYPE V-B (SHELL BUILDING PERMITTED AS V-N)

FIRE SPRINKLER SYSTEMS.

571-D BUILDING EQUIPPED WITH FIRE SPRINKLER SYSTEM 571-E BUILDING NOT EQUIPPED WITH FIRE SPRINKLER SYSTEM 571-F BUILDING NOT EQUIPPED WITH FIRE SPRINKLER SYSTEM

OCCUPANCY.

571-0 F1- FACTORY GROUP

571-E M - MERCANTILE

571-F B- BUSINESS

PLANNING INFORMATION

ZONING: CM COMMERCIAL MANUFACTURING

C-MIZONE - 1:400 AND 1 1000 FOR OUTSIDE SALES, DISPLAY OR STORAGE AREA, RETAIL AREA 1 250

571-D 12 PARKING STALLS REQUIRED 4,795 SF OF PLANT STORAGE AREAS @ 1 1000 = 5 STALLS 2,750 SF OF CM @ 1 400 = 7 STALLS

571-E 11 PARKING STALLS REQUIRED 1,886 SF OF STORAGE AREAS @ 1 1000 = 3 STALLS 900 SF OF RETAIL @ 1,250 = 4 STALLS 1,447 SF OF CM @ 1,400 = 4 STALLS

571-F 7 PARKING STALLS REQUIRED 3,133 SF OF STORAGE AREAS @ 11000 = 4 STALLS 900 SF OF CM @ 1:400 = 3 STALLS

TOTAL PARKING REQUIRED 30 STALLS

CENTRAL BUSINESS PARK WAS APPROVED WITH A RECIPROCAL PARKING AGREEMENT AND PROVIDES A TOTAL OF 221 STALLS PROJECT PROPOSES TO UTILIZE 1 RECIPROCAL STALL TO SATISFY PARKING REGUIREMENT

andrew carlos architect



ELSINORE, E & F 1 CRANE STREET, LAKE EL: 1: TENANT IMPROVEMENT

REVISIONS

PROJECT: THE BUILDING-D, E & ADDRESS: 571 C

TITLE SHEET / **GENERAL NOTES**

SHEET NUMBER

PROJECT SCOPE


PROJECT SCOPE: THE INTERIOR TENANT IMPROVEMENT OF COMMERCIAL MANUFACTURING BUILDINGS LOCATED AT 571 — DEAF CRANE STREET, LAKE ELSINGRE CA. IMPROVILENTS WILL PROVIDE FACILITIES FOR PROPOSED ACHINIST SCALLY INCLUDING ROWING, PROCESSING AND RETLA SALES.


DEFERRED SUBMITTALS

MECHANICAL DESIGN, ELECTRICAL DESIGN, MODIFICATIONS TO FIRE SUPPRESSION SYSTEMS

PROJECT GENERAL NOTES

- ALL WORK SHALL BE PERFORMED IN COMPLIANCE WITH APPLICABLE FEDERAL, STATE AND LOCAL BUILDING COORS, REGULATIONS, ORDINANCES AND STANDARDS INCLUDING ADA AND OR OTHER CA TITLE 24 AND OTHER REPUGABLE ACCESSIBLITY COORS.
- GENERAL CONTRACTOR SHALL OBTAIN AND PAY FOR PERMITS AND INSPECTIONS REQUIRED BY PUBLIC AUTHORITIES GOVERNING THE WORK.
- 5. PRIOR TO COMMENCEMENT OF ANY CONSTRUCTION, CONTRACTOR SHALL VERIFY EXISTENCE AND LOCATION OF ALL EMISTING ABOVE AND BELOW GRADE UTILITIES, INCLUDING SANITARY SEWER, STORM SEWER, WATER CAS, ELECTRICAL, TELEPOINGE, ETC. ANY DESCREMENCES IN UTILITY LOCATIONS SHALL BE BROUGHT TO THE MALEDIATE ATTENTION OF THE ARCHITECT.
- 6. GENERAL CONTRACTOR SHALL BE RESPONSIBLE FOR VERFICATION OF ALL BUILDING DIMENSIONS PRIOR TO BEGINNING CONSTRUCTION AND SHALL IMMEDIATELY NOTIFY THE ARCHITECT OF ANY VARIANCE OR DISCREPANCY AFFECTING NEW CONSTRUCTION PRIOR TO PROCEEDING WITH
- B. GENERAL CONTRACTOR SHALL COORDINATE WITH THE OWNER'S SUBCONTRACTORS AND OWNER'S VENDORS. REGARDING SCHEDULING AND SEQUENCING OF THE WORK.
- CONTRACTOR SHALL COORDINATE DESIGN, PERMITTING AND INSTALLATION TELECOMMUNICATIONS, DATA, AND SECURITY SYSTEMS WITH SUB-CONTRACTOR
- GENERAL CONTRACTOR SHALL VERIFY AND COORDINATE ALL APPLICABLE DIMENSIONS OF FIXTURES AND EQUIPMENT SUPPLIED AND/OR INSTALLED BY OTHERS,
- 12. SUBMIT REQUESTS FOR SUBSTITUTIONS, REVISION, OR CHANGES TO CONSTRUCTION DOCUMENTS TO ARCHITECT FOR REVIEW PRIOR TO PURCHASE, FABRICATION OR INSTALLATION

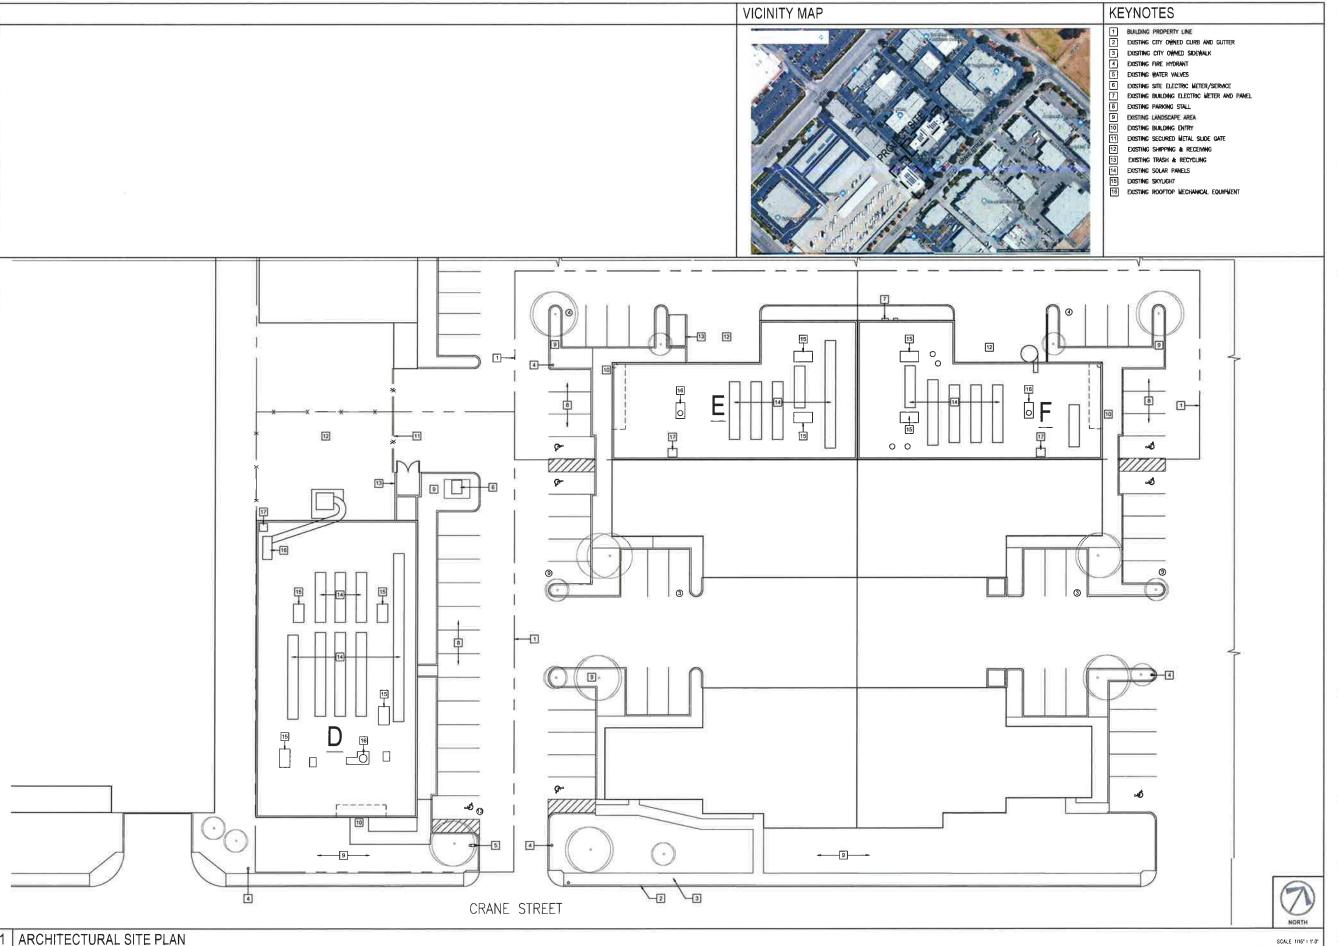

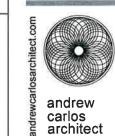




PROJECT: THE HIGHEST CRAFT TENANT IMPROVEMENT -BUILDING-D, E & F ADDRESS: 571 CRANE STREET, LAKE ELSINORE, CA 92530 DESCRIPTION: TENANT IMPROVEMENT

REVISIONS

ARCHITECTURAL SITE PLAN

SCALE 1/16" = 1'-0"

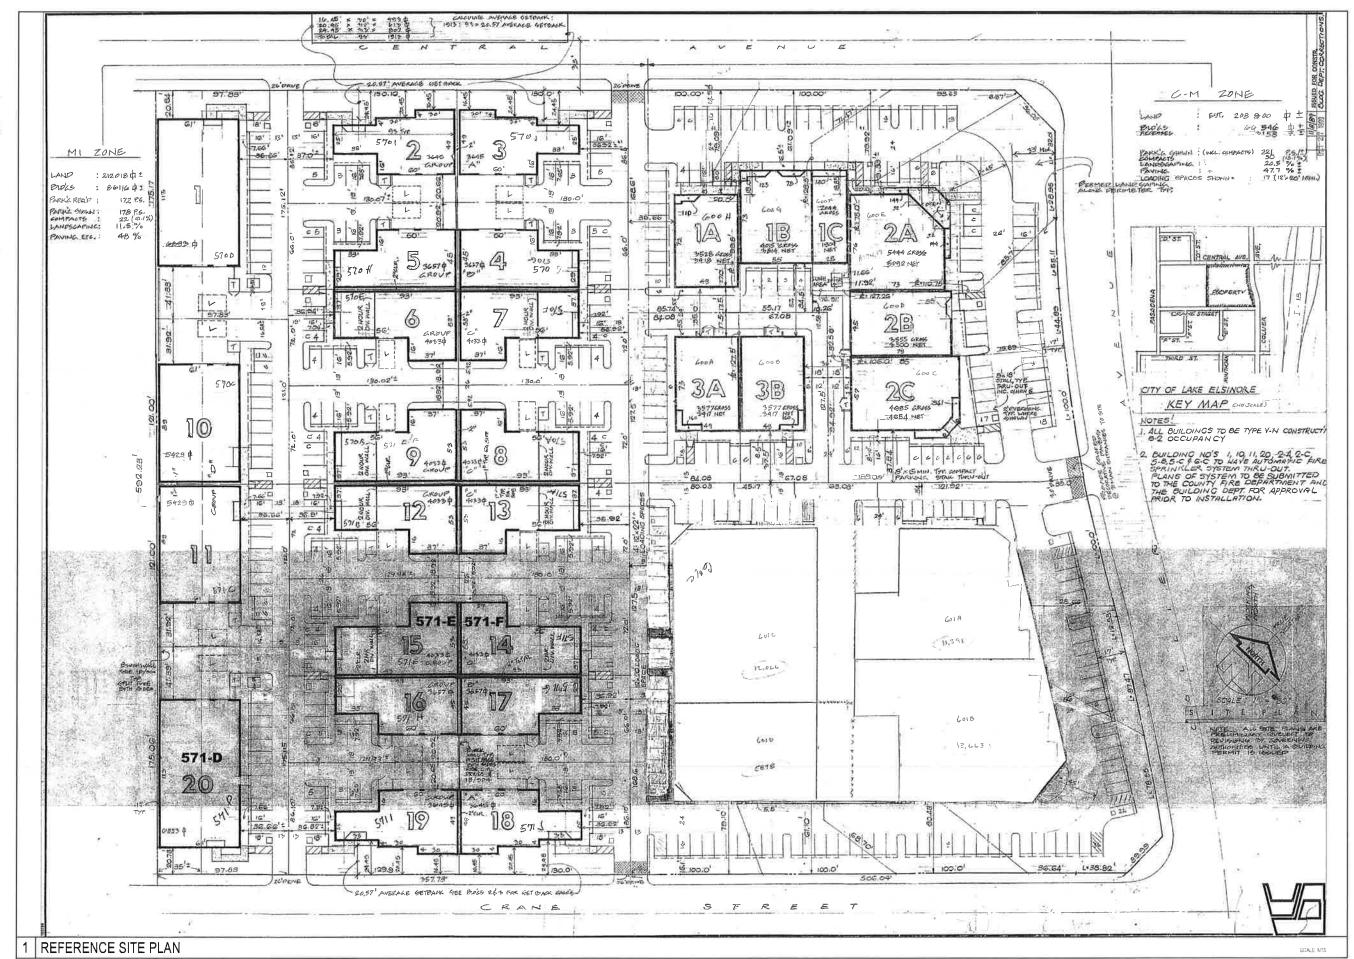






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REVISION

REFERENCE SITE PLAN

SHEET NUMBE

A-1.1

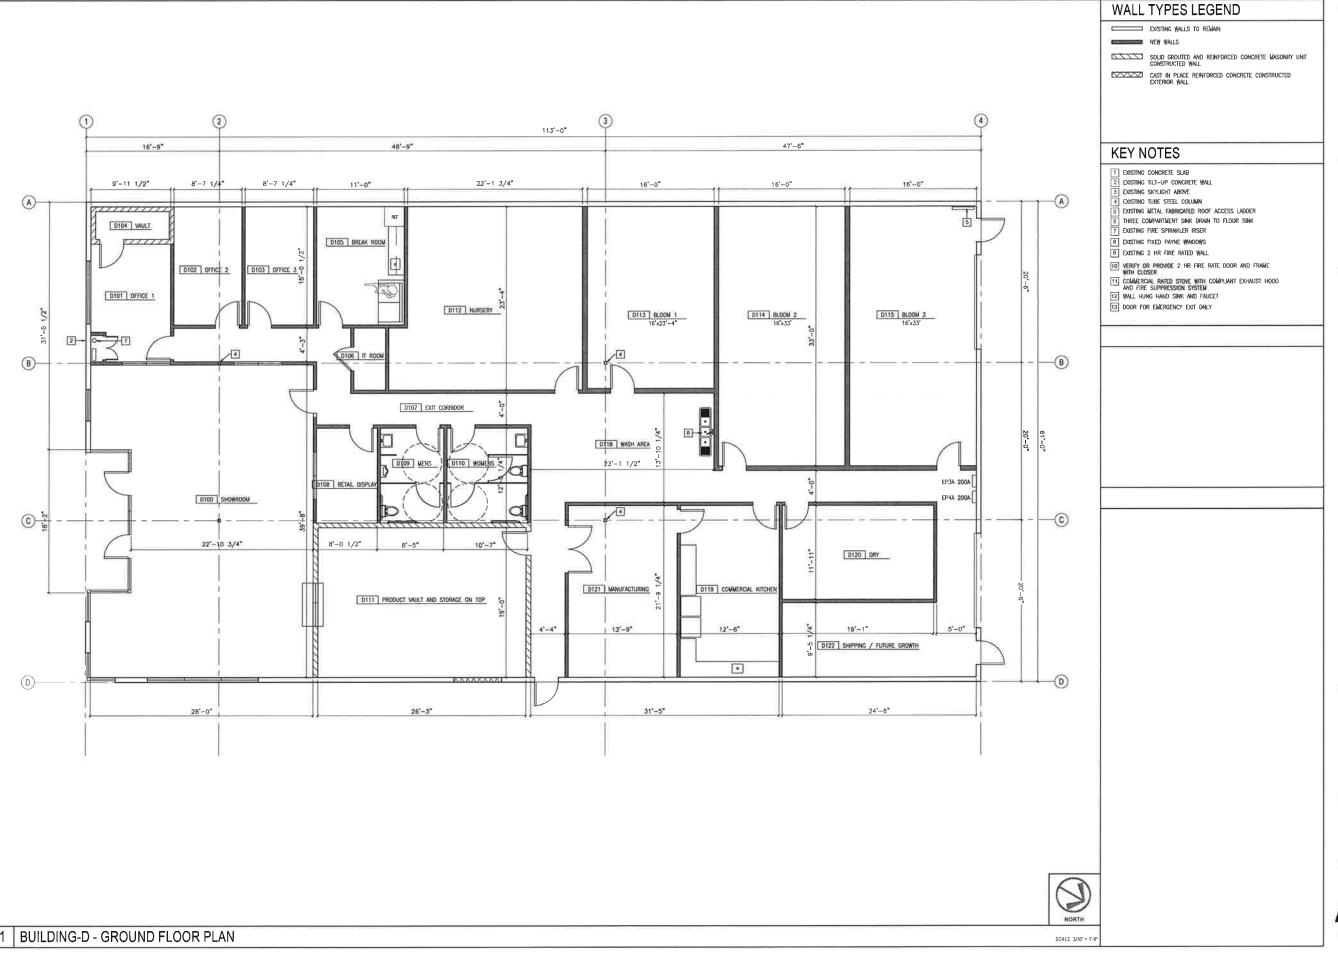

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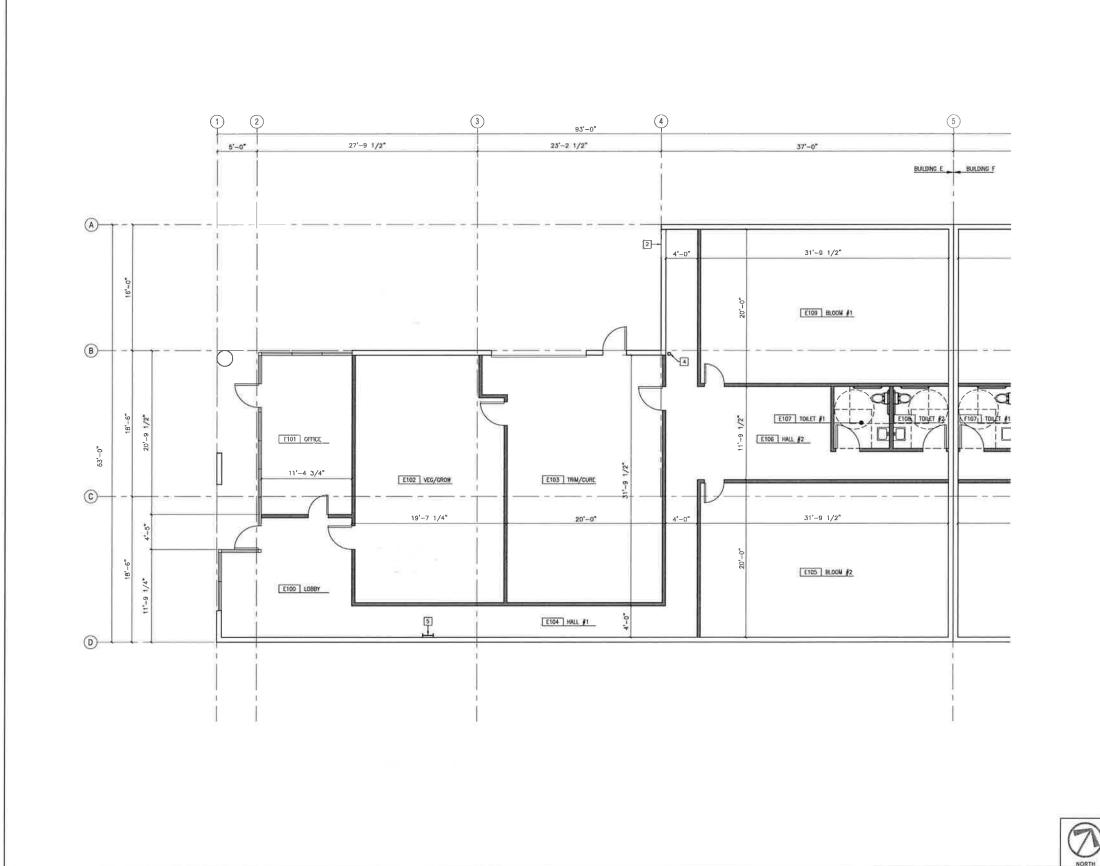
REVISIONS

ISSUE DATE:

BUILDING-D GROUND FLOOR PLAN

SHEET NUMBER

A-2.20



WALL TYPES LEGEND

EXISTING WALLS TO REMAIN

NEW WALLS

SOLID GROUTED AND REINFORCED CONCRETE MASONRY UNIT CONSTRUCTED WALL

CAST IN PLACE REINFORCED CONCRETE CONSTRUCTED EXTERIOR WALL



KEY NOTES

- 1 EXISTING CONCRETE SLAB
 2 EXISTING TILT-UP CONCRETE WALL
 3 EXISTING SKYLIGHT ABOVE
- 4 EXISTING TUBE STEEL COLUMN
- EXISTING METAL FABRICATED ROOF ACCESS LADDER
 THREE COMPARTMENT SINK DRAWN TO FLOOR SINK
 EXISTING FIRE SPRINKLER RISER
- B EXISTING FIXED PAYNE WINDOWS
- 9 EXISTING 2 HR FIRE RATED WALL
- VERIFY OR PROVIDE 2 HR FIRE RATE DOOR AND FRAME
 WITH CLOSER
 COMMERCIAL RATED STOVE WITH COMPLIANT EXHAUST HOOD
 AND FIRE SUPPRESSION SYSTEM
 WALL HUNG HAND SINK AND FAUCET
 DOOR FOR EMERGENCY EXIT ONLY



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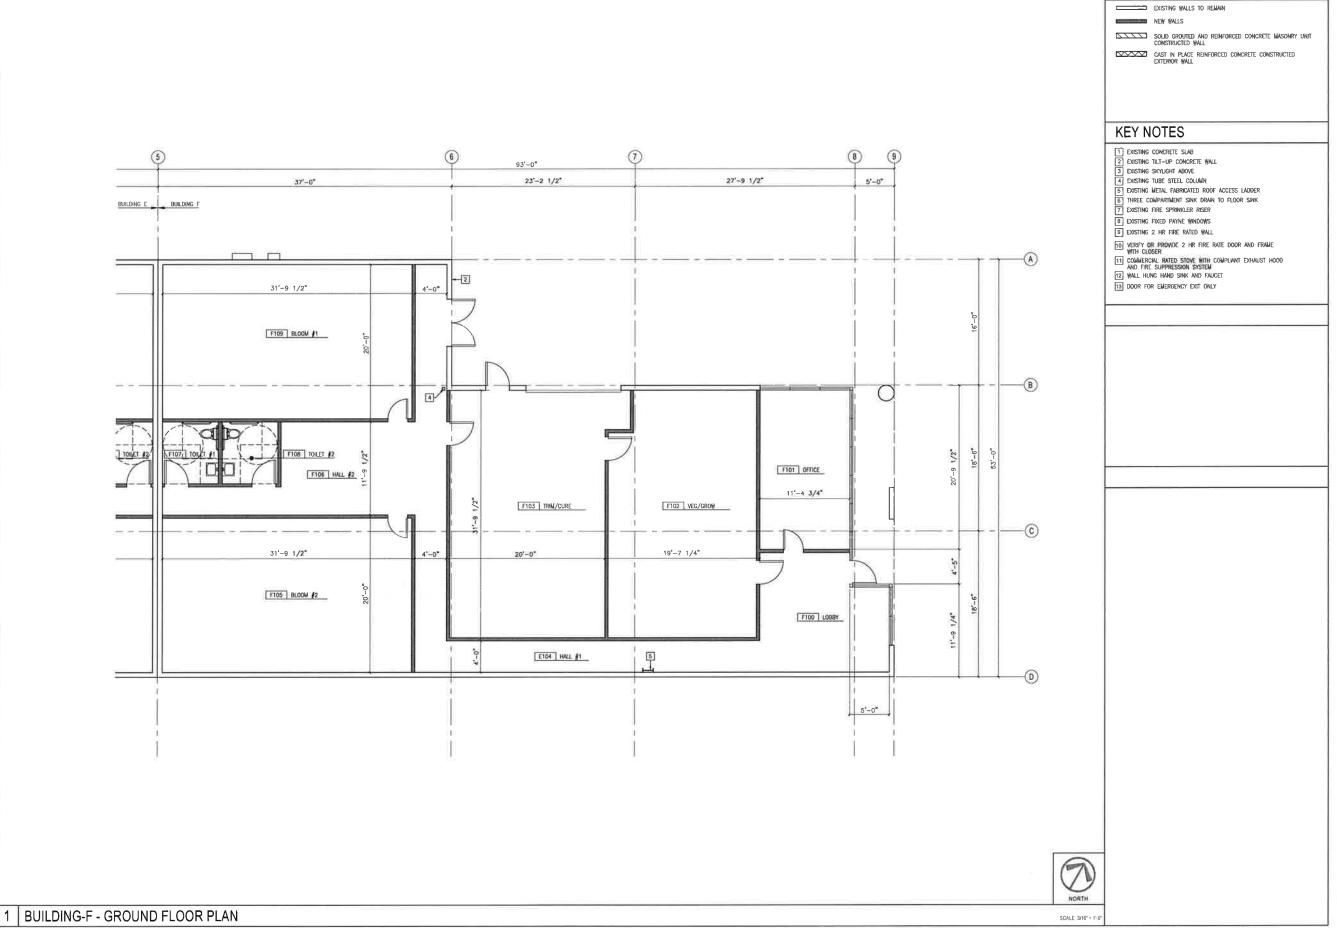
REVISIONS

ISSUE DATE:

BUILDING-E GROUND FLOOR PLAN

SCALE 3/16' = 1'-0

1 BUILDING-E - GROUND FLOOR PLAN



WALL TYPES LEGEND

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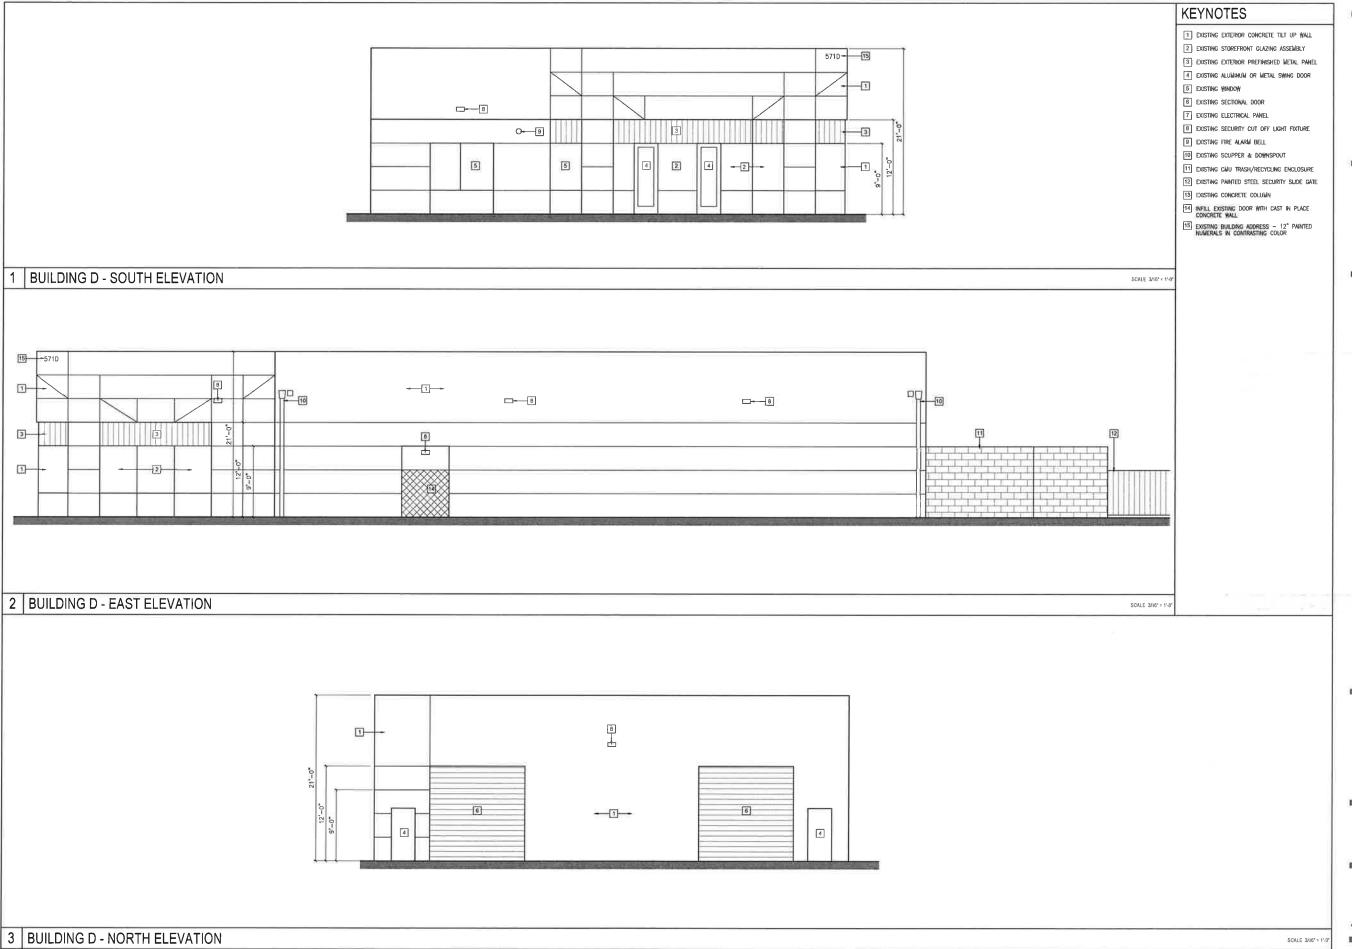


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REVISIONS

ISSUE DATE:

BUILDING-F GROUND FLOOR PLAN







architect


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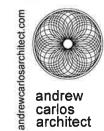
REVISIONS

BUILDING D EXTERIOR ELEVATIONS

SHEET NUMB

A-3.0



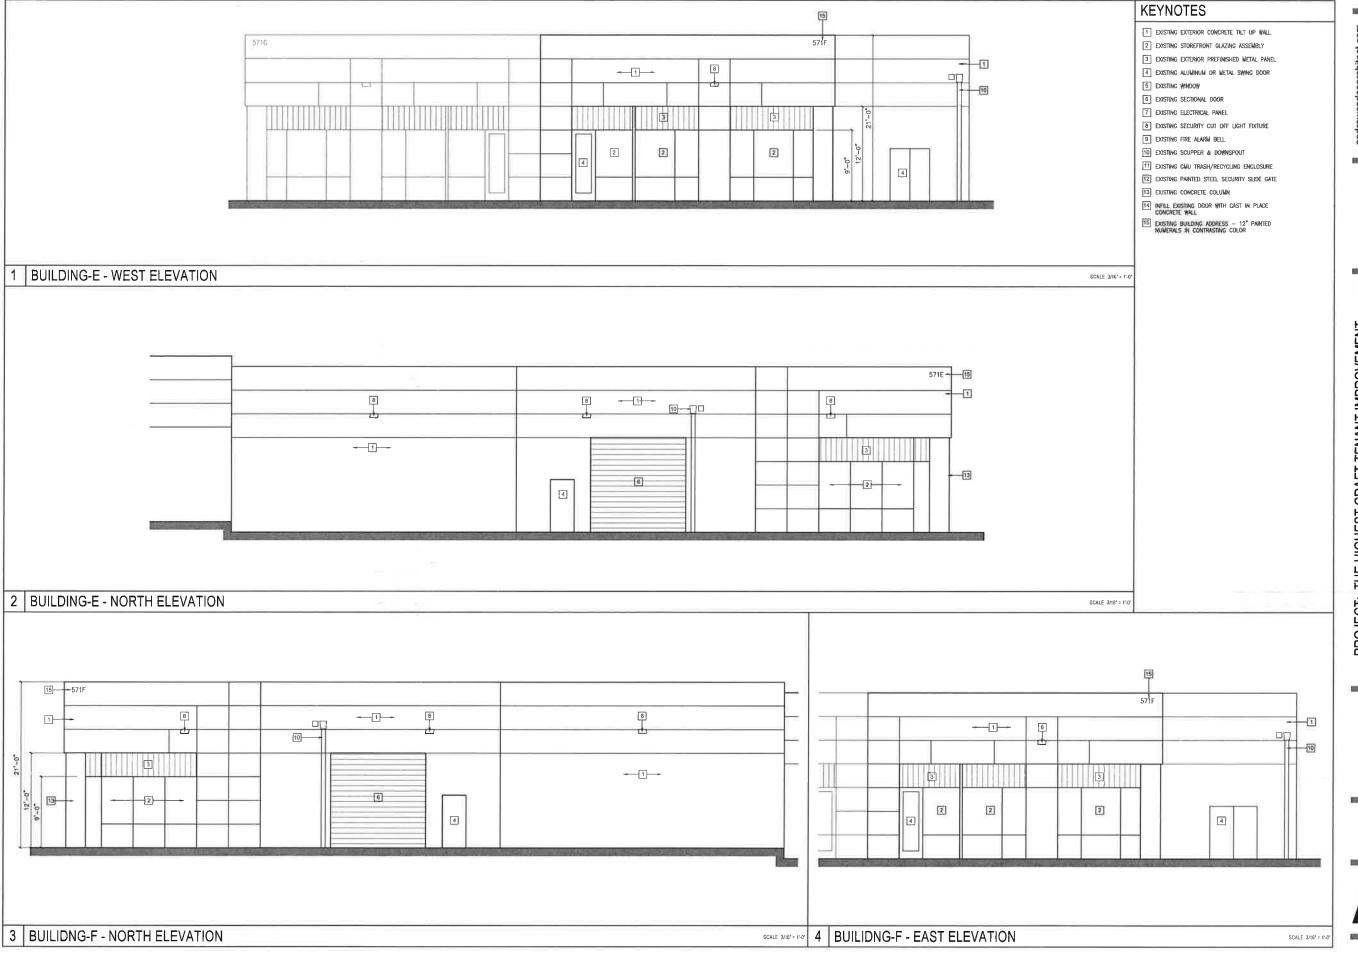



PROJECT: THE HIGHEST CRAFT TENANT IMPROVEMENT -BUILDING-D, E & F ADDRESS: 571 CRANE STREET, LAKE ELSINORE, CA 92530 DESCRIPTION: TENANT IMPROVEMENT

REVISIONS

BUILDING-E & F EXTERIOR ELEVATIONS

SHEET NUMBER

A-3.1