CODE INFORMATION

BUILDING CODE:
CBC 2016
PLUMBING CODE:
CPC 2016
MECHANICAL CODE:
CMC 2016
ELECTRICAL CODE:
CEC 2016
ENERGY CODE:
TITLE 24 - 2016 EDITION
FIRE CODE:
CFC 2016
GREEN CODE:
CGC 2016
LOCAL CODE AMENDMENTS:
LA AMENDMENTS APPLICABLE.

BUILDING DATA

OCCUPANCY:

FIRE SPRINKLERED:

CONSTRUCTION TYPE:

SITE AREA:

BUILDING AREA:

42 (RESTAURANT)

YES

V-B

49,659 S.F.

4,801 S.F.

FAR: .09
ZONING: C-2 GENERAL COMMERCIAL



PARKING

STANDARD SPACES REQUIRED: | FO

I FOR 45SF OF CUSTOMER SPACE I ADDITIONAL FOR 200SF NON-CUSTOMER

SPACE

CUSTOMER AREA: 1,893 SF/45

TOTAL SPACES REQUIRED: CUSTOMER AREA:

NON-CUSTOMER AREA: 2,908 SF/200 TOTAL REQUIRED

REQUIRED = 60 SPACES

= 42

= 15

TOTAL SPACES PROVIDED: 59 SPACES PROVIDED

Archit∈ct:

C.R.H.O.
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JOHN HOURIAN & ASSOC.

107 AVENIDA MIRAMAR, SUITE "D"

SAN CLEMENTE, CA 92672

PHONE: (949) 489-5623

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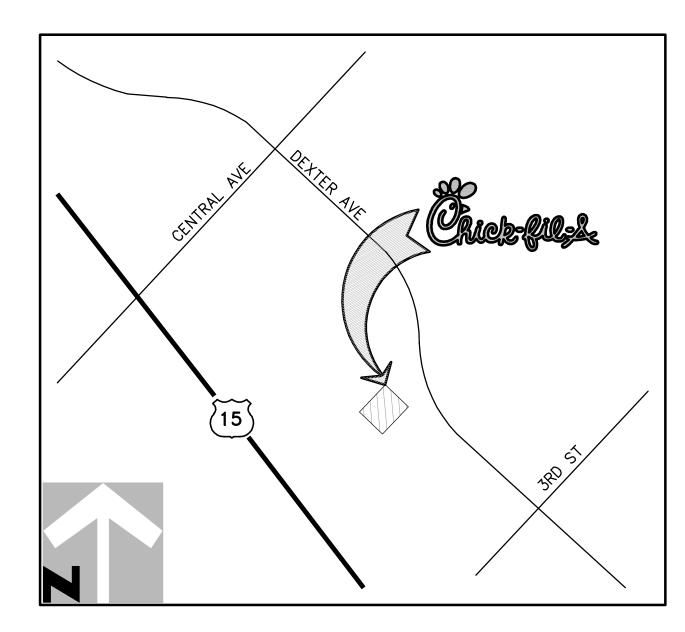
CONTACT: JOHN HOURIAN

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5200 BUFFINGTON ROAD ATLANTA, GEORGIA 30349-2998 PHONE: (404) 765-8000 FAX: (404) 684-8550

18601 DEXTER AVE. LAKE ELSINORE, CA 92532



VICINITY MAP

NOT TO SCALE

Drawing Index

T-I.I COVER SHEET SP-I SITE PLAN

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A-1.0 FLOOR PLAN A-1.7 ROOF PLAN

A-2.1 EXTERIOR ELEVATIONS

A-3.1 BUILDING SECTION



5200 Buffington Rd. Atlanta Georgia, 30349—2998

Revisions: Mark Date By

Mark Date By

Mark Date By

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STORE
CENTRAL AVE &
DEXTER AVE.

phone 714.832.1834

18601 DEXTER AVE. LAKE ELSINORE, CA

SHEET TITLE
TITLE SHEET

VERSION: V7.025 ISSUE DATE: 08-2016

 Job No.
 : 17-200


 Store
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 Date
 : 03-07-18

Drawn By : AM
Checked By: RH

Shoot

T-I.I

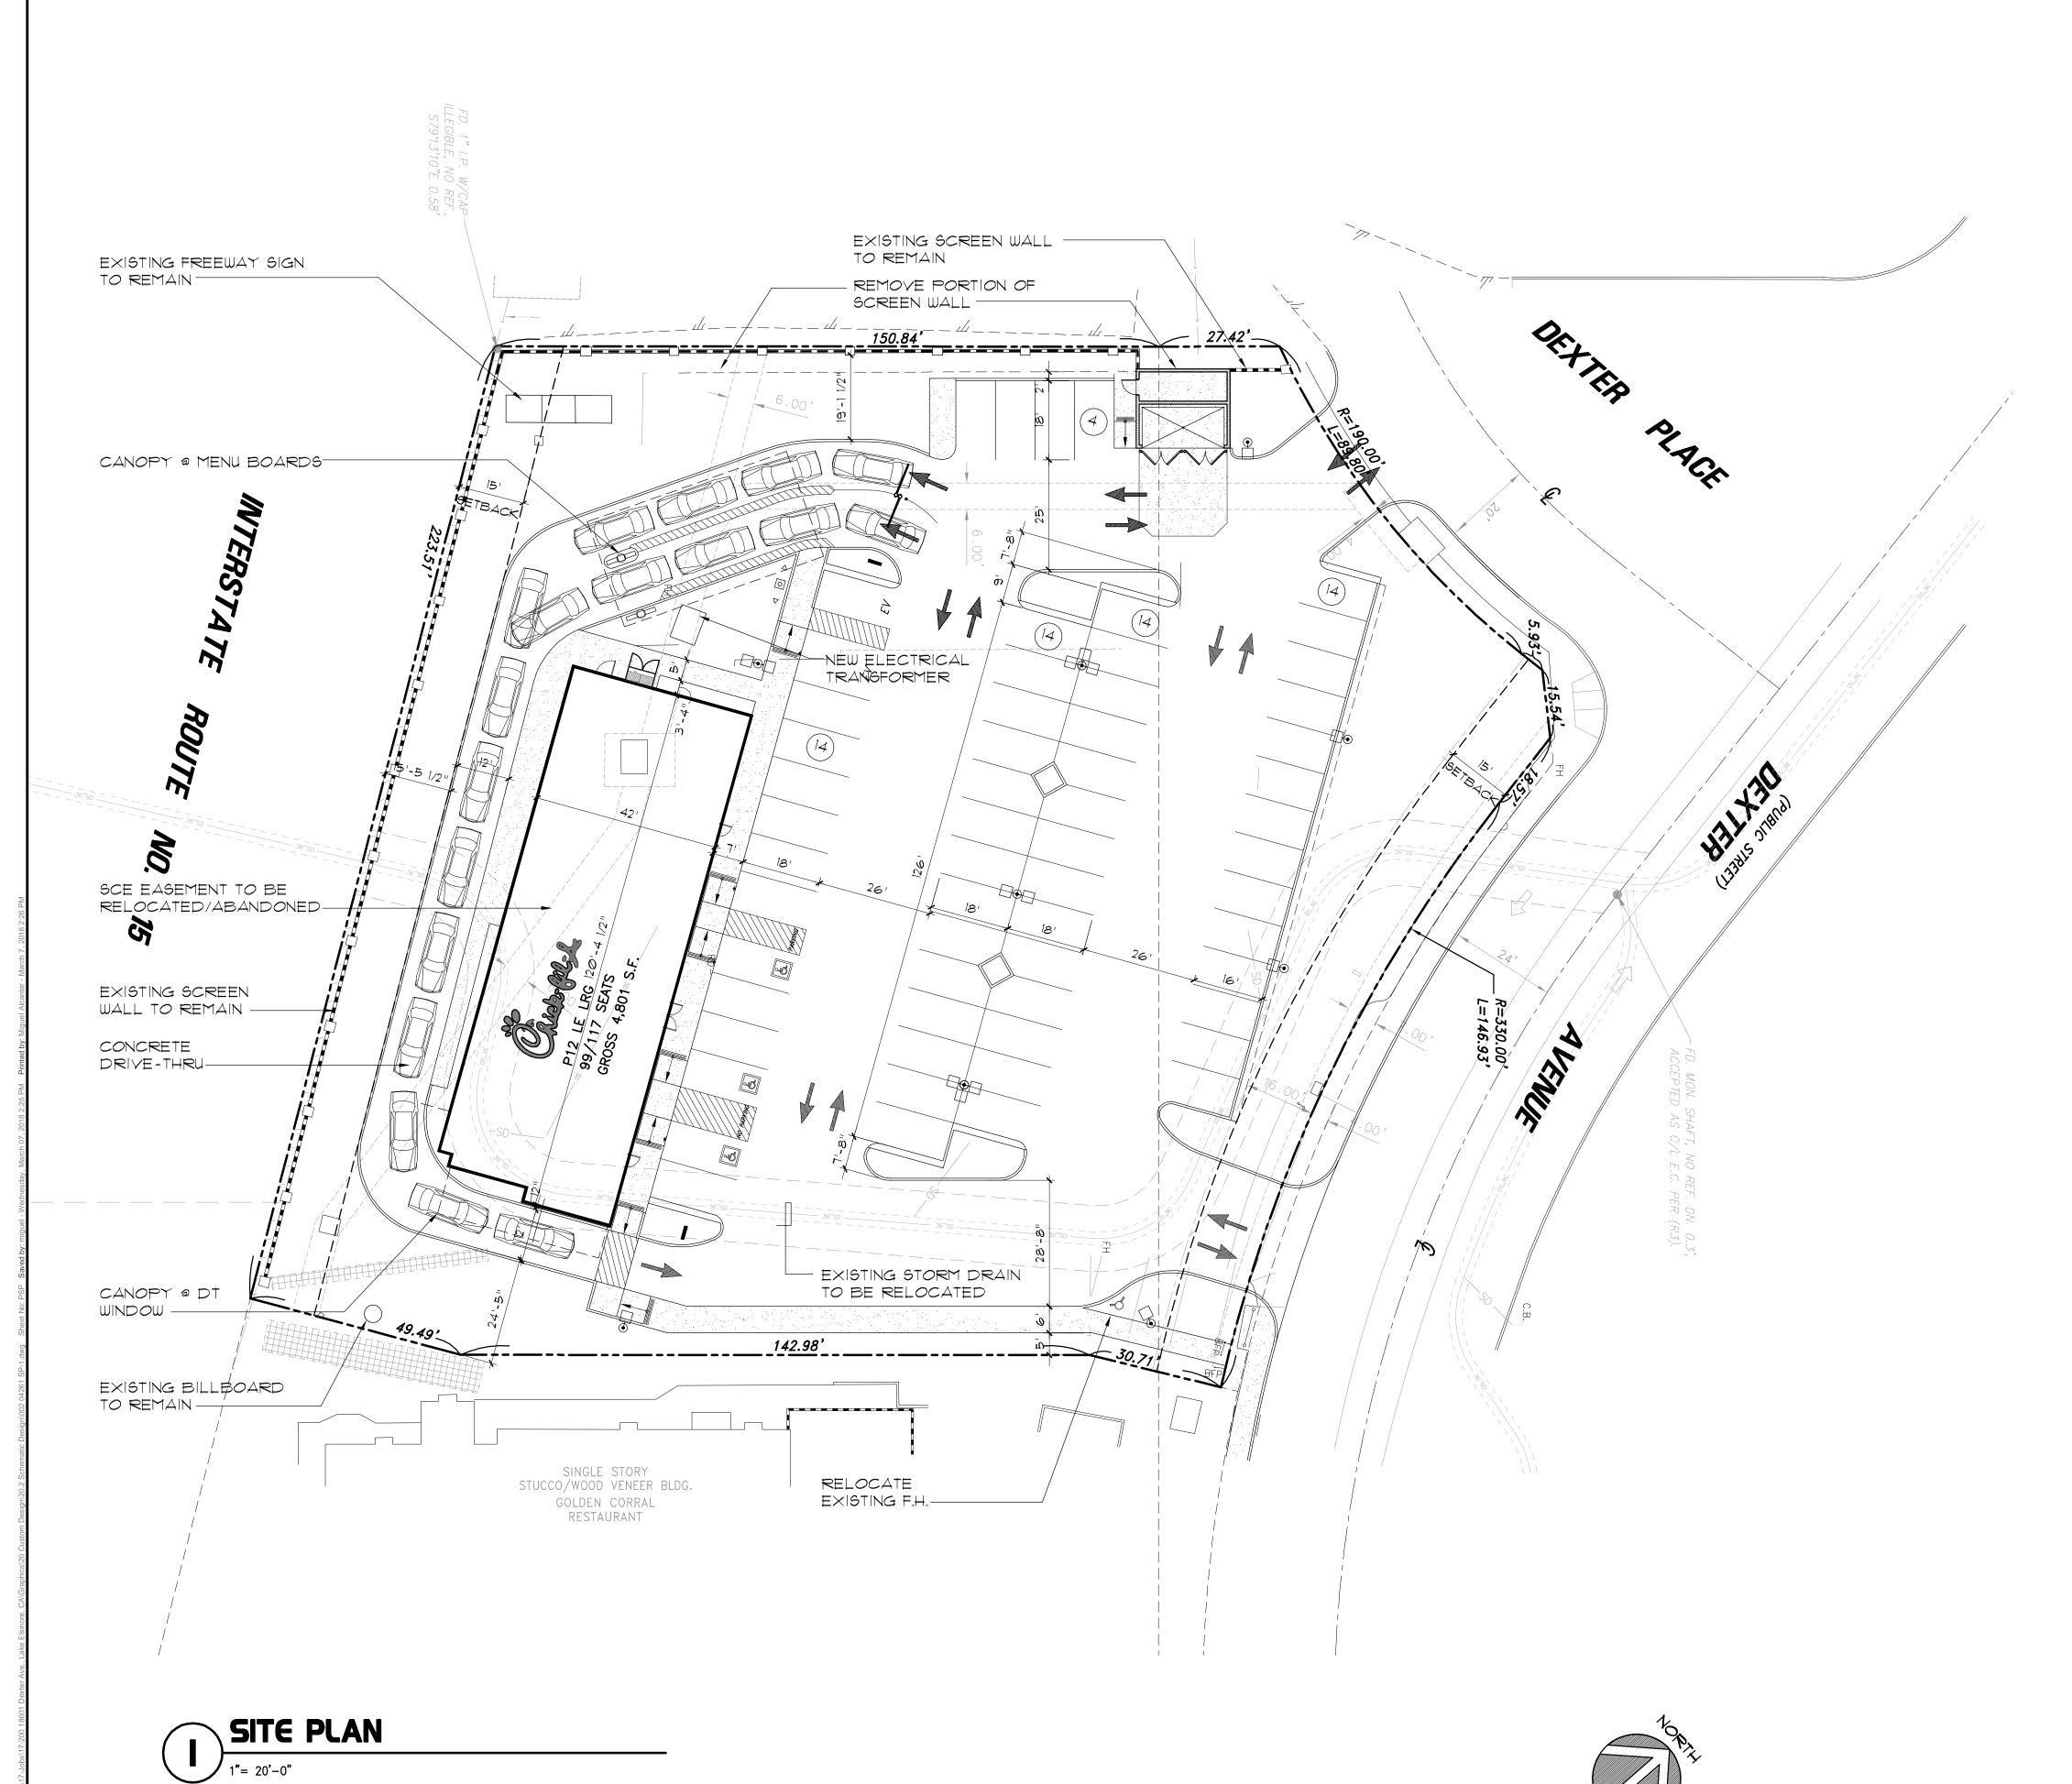

BUILDING DATA

OCCUPANCY: A2 (RESTAURANT)

FIRE SPRINKLERED: YES CONSTRUCTION TYPE: V-B SITE AREA: 46,659S.F. BUILDING AREA: 4,801 S.F.

FAR: .09

ZONING: C2 GENERAL COMMERCIAL

PARKING

STANDARD SPACES REQUIRED: I FOR 45SF OF CUSTOMER SPACE

1 ADDITIONAL FOR 200SF NON-CUSTOMER SPACE

CUSTOMER AREA: TOTAL SPACES REQUIRED: 1,893 SF/45 NON-CUSTOMER AREA: 2,908 SF/200 TOTAL REQUIRED = 15

= 57 SPACES

TOTAL SPACES PROVIDED: 60 SPACES PROVIDED







5200 Buffington Rd. Atlanta Georgia, 30349-2998

Mark Date By

Mark Date By

Mark Date By



CENTRAL AVE & DEXTER AVE.

phone 714.832.1834

18601 DEXTER AVE. LAKE ELSINORE, CA

PRELIMINARY SITE PLAN

VERSION: V7.025
ISSUE DATE: 08-2016

: <u>17-200</u> : __04261 : <u>03-07-18</u>

Checked By:_--

SP-I

CONCEPTUAL GRADING AND UTILITY PLANS

UTILITY PROVIDERS **

...ELSINORE VALLEY MUNICIPAL WATER DISTRICT, 31315 CHANEY STREET, LAKE ELSINORE 92530, CHRISTINA BACHINSKI (951) 674–3146 x8427ELSINORE VALLEY MUNICIPAL WATER DISTRICT, 31315 CHANEY STREET, LAKE ELSINORE 92530, CHRISTINA BACHINSKI (951) 674-3146 x8427

STORM DRAIN.....CITY OF LAKE ELSINORE, 130 S. MAIN STREET, LAKE ELSINORE 92530, RITA THOMPSON (951) 674-3121 x308 ...SO. CALIF. GAS CO., 1981 W. LUGONIA AVENUE, REDLANDS 92374, ROBERT FIGUEROA (909) 335-7755SO. CALIF. EDISON, 24487 PRIELIPP DRIVE, WILDOMAR 92595, SCE PLANNING SUPERVISOR (951) 249-8301CHARTER COMMUNICATIONS, 560 S. PROMENADE AVE. #102, CORONA 92879, KEITH KLUMP (951) 547-3831

ROADWAY......CITY OF LAKE ELSINORE, 130 S. MAIN STREET, LAKE ELSINORE 92530. RITA THOMPSON (951) 674-3124 x308COUNTY OF RIVERSIDE TRANSPORTATION DEPT., 4080 LEMON ST. 3RD FLOOR, RIVERSIDE 92501, (951) 955-6880

CHICK-FIL-A RESTAURANT NO. 4261 CENTRAL AVENUE AND DEXTER AVENUE LAKE ELSINORE, CA

NPDES PERMIT UNDER THE STATEWIDE GENERAL PERMIT CONSTRUCTION ACTIVITY.

4. POTENTIAL POLLUTANTS INCLUDE BUT ARE NOT LIMITED TO: SOLID OR LIQUID CHEMICAL SPILLS;

STEAM CLEANING OR CHEMICAL DEGREASING; WASTES FROM STREET CLEANING; AND

MUST NOT BE DISCHARGED TO RECEIVING WATERS OR THE LOCAL STORM DRAIN SYSTEM.

IMPLEMENTED TO ELIMINATE OR REDUCE TRANSPORT FROM THE SITE TO STREETS, DRAINAGE

7. MATERIAL STORAGE AND STAGING AREAS SHALL BE ESTABLISHED. FUEL TANK, PORTABLE TOILETS,

LIQUIDS, GELS AND POWDERS SHALL HAVE SECONDARY CONTAINMENT AND BE STORED AWAY FROM

ALL PRIVATE / PUBLIC STORM WATER CONVEYANCE SYSTEMS, SIDEWALKS, RIGHTS-OF-WAYS AND

8. ALL PORTABLE MIXERS SHALL HAVE PLASTIC LINERS UNDERNEATH WITH GRAVEL BAGS PLACES ON THE

9. CONTROLLED STREET WASHING WILL ONLY BE ALLOWED PRIOR TO THE APPLICATION OF ASPHALT SEAL

10. ALL CONSTRUCTION CONTACTORS AND SUBCONTRACTOR PERSONNEL ARE TO BE MADE AWARE OF THE

11. DISCHARGING CONTAMINATED GROUNDWATER PRODUCED BY DEWATERING GROUNDWATER THAT HAS

INFILTRATED INTO THE CONSTRUCTION SITE IS PROHIBITED. DISCHARGING NON-CONTAMINATED

GROUNDWATER PRODUCED BY DEWATERING ACTIVITIES MAY REQUIRE A NATIONAL POLLUTANT

12. STORM WATER RUNOFF SHALL NOT BE DIRECTED OVER ANY SLOPES WITHOUT PERMANENT DOWN

DISCHARGE ELIMINATION SYSTEM (NPDES) PERMIT FROM THE REGIONAL WATER QUALITY CONTROL

DRAINS INSTALLED. EROSION AND SEDIMENT CONTROLS INCLUDING MAINTENANCE ARE REQUIRED ON

ALL EXPOSED SLOPES UNTIL SUFFICIENT PERMANENT LANDSCAPING HAS BEEN ESTABLISHED. 100%

VEGETATION CLEARING AND BRUSHING ACTIVITIES SHALL NOT BE INITIATED DURING THE WET SEASON

SLOPE PROTECTION MUST BE IN PLACE PRIOR TO THE ISSUANCE OF THE FINAL CERTIFICATE OF

ON ANY SITES WHICH ARE NOT ADEQUATELY PROTECTED WITH DESILTING BASINS OR OTHER

14. STOCKPILES OF SOIL SHALL BE PROPERLY SECURED WITH BMP'S TO ELIMINATE OR REDUCE SEDIMENT

15. STOCKPILES OF SOIL SHALL BE PROPERLY CONTAINED TO ELIMINATE OR REDUCE SEDIMENT TRANSPORT

TRACKING OR WIND. INACTIVE FOR A PERIOD OF 14 DAYS OR MORE SHALL BE COVERED; ACTIVE

16. FOR PROJECT REQUIRING COVERAGE UNDER THE CONSTRUCTION GENERAL PERMIT, SPECIAL ATTENTION

17. AT THE END OF EACH DAY OF CONSTRUCTION ACTIVITY, ALL CONSTRUCTION DEBRIS AND WASTE

MATERIALS SHALL BE COLLECTED AND PROPERLY DISPOSED OF IN COVERED TRASH OR COVERED

18. THIS SITE HAS OBTAINED A NATIONAL POLLUTION PREVENTION ELIMINATION SYSTEM (NPDES) PERMIT

TO REGULATE MUNICIPAL AND INDUSTRIAL STORM WATER DISCHARGES. NPDES WDID

19. THE UNDERSIGNED CIVIL ENGINEER, A QUALIFIED QSP AND/OR QSD WILL REVIEW PLACEMENT OF

(R1) = RECORD DATA PER LOT LINE ADJUSTMENT NO. 2007-12, RECORDED

(R3) = CALTRANS R/W MAP 916532, RECORDS OF CALTRANS DISTRICT NO. 8

THE BEARING NORTH 08° 01' 28" WEST FOR THE CENTERLINE OF DEXTER

MARCH 18, 2008 AS INSTRUMENT NO. 2008-0131995 OF MAPS, RECORDS

OF THE COUNTY OF RIVERSIDE, STATE OF CALIFORNIA, WAS USED AS THE

AVENUE AS SHOWN ON LOT LINE ADJUSTMENT NO. 2007-12 RECORDED

CHISELED SQUARE ON TOP OF HEADWALL. FROM THE APPROXIMATE

NORTHWESTERLY ALONG COLLIER AND 45 FEET SOUTHWESTERLY TO

AREA DETERMINED TO BE OUTSIDE THE 0.2% ANNUAL CHANCE FLOODPLAIN.

INFORMATION OBTAINED FROM CERTIFIED FLOOD SYSTEMS, INC. ON 12/8/17

ZONE X (UNSHADED): PROPERTY NOT IN A SPECIAL FLOOD HAZARD AREA.

INTERSECTION OF COLLIER AVENUE AND THIRD STREET 45 FEET

MARCH 18, 2008 AS INSTRUMENT NO. 2008-0131995, OFFICIAL RECORDS

EROSION CONTROL AND INSURE THAT WORK IS IN ACCORDANCE WITH THE APPROVED PLANS.

(SIGNATURE) (RCE NO.) (EXP) (DATE)

SHALL BE GIVEN TO PREPARATION AND INSTALLATION OF THE RAIN EVENT ACTION PLAN (REAP) AS

FROM THE SITE TO STREETS DRAINAGE FACILITIES OR ADJACENT PROPERTIES VIA RUNOFE VEHICLE

TRANSPORT FROM THE SITE TO STREETS, DRAINAGE FACILITIES OR ADJACENT PROPERTIES.

REQUIRED BMPS AND GOOD HOUSEKEEPING MEASURES FOR THE PROJECT SITE AND ANY ASSOCIATED

IN ACCORDANCE WITH LOCAL, STATE AND FEDERAL REQUIREMENTS.

FACILITIES, OR ADJOINING PROPERTIES BY WIND OR RUNOFF.

DOWN-HILL SIDE OF THE LINERS TO CONTAIN DISCHARGES.

COATS AND ONLY WHEN ALL PERTINENT DRAINAGE INLETS ARE PROTECTED.

FLOW-LINES.

BOARD.

CONSTRUCTION STAGING AREAS.

TEMPORARY DRAINAGE OR CONTROL MEASURES.

STOCKPILES SHALL BE COVERED PRIOR TO A FORECASTED RAIN.

PERMIT, GENERAL PERMIT CONSTRUCTION ACTIVITIES.

#_____ DATE WDID ISSUED: _____

(R2) = PARCEL MAP 8914, BOOK 34, PAGE 84.

BASIS OF BEARINGS **

BASIS OF BEARINGS FOR THIS SURVEY.

ELEVATION = 1270.68 FEET (DEC. 1995)

BENCHMARK **

FLOOD ZONE **

SITE AREA **

SUBJECT SITE CONTAINS APPROXIMATELY:

GROSS TO P/L = 52,717 SQUARE FEET OR 1.210 ACRES

NET TO R/W = 49,872 SQUARE FEET OR 1.145 ACRES

(DE) = MISCELLANEOUS RECORD DEED LEGAL DESCRIPTION.

CITY OF LAKE ELSINORE BENCHMARK NO. B-95-55

THE SOUTHERLY END OF HEAD WALL AT CHANNEL.

RECORD DATA **

WASTES FROM PAINTS, STAINS, SEALANTS, SOLVENTS, DETERGENTS, GLUES, LIME, PESTICIDES,

HERBICIDES, FERTILIZERS, WOOD PRESERVATIVES, AND ASBESTOS FIBERS, PAINT FLAKES OR STUCCO

AND RELATED CUTTING OR CURING RESIDUES; FLOATABLE WASTES; WASTES FROM ENGINE/EQUIPMENT

FRAGMENTS; FUELS, OILS LUBRICANTS, AND HYDRAULIC, RADIATOR OR BATTERY FLUIDS; CONCRETE

SUPER—CHLORINATED POTABLE WATER FROM LINE FLUSHING AND TESTING. DURING CONSTRUCTION,

DISPOSAL OF SUCH MATERIALS SHOULD OCCUR IN A SPECIFIED AND CONTROLLED TEMPORARY AREA

ON-SITE PHYSICALLY SEPARATED FROM POTENTIAL STORM WATER RUNOFF, WITH ULTIMATE DISPOSAL

RUNOFF FROM EQUIPMENT AND VEHICLE WASHING SHALL BE CONTAINED AT CONSTRUCTION SITE AND

APPROPRIATE BMPS FOR CONSTRUCTION-RELATED MATERIALS, WASTES, SPILLS OR RESIDUES SHALL BE

+ AGENCY RECORD INFORMATION NOT AVAILABLE AT THE TIME OF THIS SURVEY.

GRADING NOTES

+ PHONE....

- ALL WORK SHALL BE DONE IN ACCORDANCE WITH THE CITY OF LAKE ELSINORE MUNICIPAL CODE, CHAPTER 15.72 AND APPLICABLE STANDARDS AND SPECIFICATIONS AND THE LATEST EDITION OF THE UNIFORM BUILDING CODE (U.B.C.), CHAPTER 33.
- TO ANY OPERATIONS.
- (1-800-422-4133) FORTY-EIGHT (48) HOURS PRIOR TO GRADING.
- THE CONTRACTOR SHALL NOTIFY THE CITY ENGINEERING DEPARTMENT AT LEAST TWENTY-FOUR (24) HOURS IN ADVANCE OF BEGINNING GRADING OPERATIONS.
- DUST SHALL BE CONTROLLED BY WATERING OR OTHER METHODS APPROVED BY THE CITY ENGINEER.
- CUT SLOPES SHALL BE NO STEEPER THAN 2 HORIZONTAL TO 1 VERTICAL, UNLESS OTHERWISE APPROVED, AND SHALL BE SHOWN ON THE PLAN.
- FILL SLOPES SHALL BE NO STEEPER THAN 2 HORIZONTAL TO 1 VERTICAL, UNLESS OTHERWISE APPROVED, SHALL BE SHOWN ON PLAN, AND SHALL NOT HAVE LESS THAN 90% RELATIVE COMPACTION OUT TO THE FINISHED SURFACE.
- FILLS SHALL BE COMPACTED THROUGHOUT TO 90% DENSITY AS DETERMINED BY THE MODIFIED THREE
- (3) LAYER A.S.T.M. D-1557-70 TEST METHOD. FILL AREAS SHALL BE CLEANED OF ALL VEGETATION AND DEBRIS, SCARIFIED, AND INSPECTED BY THE

GRADING INSPECTOR AND APPROVED SOILS TESTING AGENCY PRIOR TO THE PLACING OF FILL.

-). ALL FILL MATERIAL SHALL BE CLEAN EARTH. NO FILL SHALL BE PLACED UNTIL PREPARATION OF GROUND IS APPROVED BY THE SOILS ENGINEER.
- FOR A MINIMUM OF THREE (3) FEET, THEN 1% (MINIMUM) TO FLOW LINE OF EARTH SWALE.
- MINIMUM BUILDING PAD AND DRAINAGE SWALE SLOPE SHALL BE 1% IF CUT OR FILL SLOPE IS LESS THAN TEN FEET (10FT), AND 2% IF CUT OR FILL IS GREATER THAN TEN FEET (10FT). DRAINAGE SWALES SHALL BE A MINIMUM OF 0.5FT DEEP AND CONSTRUCTED A MINIMUM OF TWO FEET (2') FROM THE TOP OF CUT OR FILL SLOPES.
- 3. PROVIDE 5FT WIDE BY 1FT HIGH BERM OR EQUIVALENT ALONG THE TOP OF ALL FILL SLOPES OVER
- 4. PROVIDE A BROW DITCH, DESIGNED TO HANDLE ONE HUNDRED (100) YEAR STORM FLOWS ALONG THE TOP OF CUT SLOPES.
- 15. NO OBSTRUCTION OF FLOOD PLAINS OR NATURAL WATER COURSES SHALL BE PERMITTED.
- 6. A SOILS ENGINEER SHALL BE RETAINED BY THE DEVELOPER, TO SUPERVISE GRADING AND PROVIDE A FINAL SOILS REPORT WHICH INCLUDES FOUNDATION REQUIREMENTS (SUBDIVISIONS) AND EXPANSIVE CHARACTERISTICS OF THE SOIL.
- 7. GRADING CERTIFICATION BY THE DEVELOPER'S CIVIL ENGINEER AND A FINAL COMPACTION REPORT BY A SOILS ENGINEER SHALL BE SUBMITTED TO THE BUILDING AND ENGINEERING DEPARTMENTS PRIOR TO ISSUANCE OF BUILDING PERMITS.
- 18. THE SOILS ENGINEERING INVESTIGATION DATED <u>JANUARY 23, 2018</u> PREPARED BY (GILES ENGINEERING ASSOCIATES, INC.) DATED _____ AND THE ENGINEERING GEOLOGIC INVESTIGATION DATED PREPARED BY (GEOLOGIC CONSULTANT). SHALL BE CONSIDERED A PART OF THIS GRADING PLAN AND SHALL BE IN COMPLIANCE.
- 19. A REGISTERED CIVIL ENGINEER OR LICENSED LAND SURVEYOR SHALL SUBMIT CERTIFICATION OF BUILDING PAD ELEVATION. WHERE SPECIFIC ELEVATIONS ARE REQUIRED, THE ELEVATION (WITH RESPECT TO MEAN SEA LEVEL) SHALL BE GIVEN. IF AN ELEVATION WITH RESPECT TO ADJACENT GROUND SURFACE IS REQUIRED, THE ACTUAL DISTANCE ABOVE THE ADJACENT GROUND SHALL BE GIVEN.
- 20. ALL PROPERTY CORNERS SHALL BE CLEARLY DELINEATED IN THE FIELD PRIOR TO COMMENCEMENT OF 11. DESILTING FACILITIES AT ALL DRAINAGE INLETS FOR THE GRADED SITE SHALL BE DESIGNED FOR A ANY CONSTRUCTION/GRADING.
- . STABILITY CALCULATIONS WITH A SAFETY FACTOR OF AT LEAST 1.5 SHALL BE SUBMITTED BY A SOILS ENGINEER TO THE BUILDING AND ENGINEERING DEPARTMENTS FOR CUT AND FILL SLOPES OVER THIRTY FEET (30') IN VERTICAL HEIGHT.
- 22. A FINAL COMPACTION REPORT WILL BE REQUIRED FOR ALL FILLS GREATER THAN ONE (1) FOOT.
- 23. IF STEEP SLOPING TERRAIN OCCURS UPON WHICH FILL IS TO BE PLACED. IT MUST BE CLEARED. KEYED AND BENCHED INTO FIRM NATURAL SOIL FOR FULL SUPPORT. PREPARATION SHALL BE APPROVED BY A REGISTERED SOILS ENGINEER PRIOR TO PLACEMENT OF FILL MATERIAL. SLOPES GREATER THAN 5:1 ARE REQUIRED TO BE KEYED AND BENCHED.
- 24. THE SOILS ENGINEER SHOULD INSPECT THE CONSTRUCTION IN THE FOLLOWING STAGES: A. UPON COMPLETION OF CLEARING AND DURING EXCAVATION AND BEFORE BACKFILL OF ALLUVIAL, COLLUVIAL AND TERRACED AREAS AND ANY SUBSTRUCTURES. B. DURING ALL ROUGH GRADING AND OPERATIONS INCLUDING PRE-COMPACTION, BENCHING AND FILLING OPERATIONS. C. DURING INSTALLATION OF BUTTRESS AND CANYON SUB-DRAINS AND FILTER MATERIAL. D. WHEN ANY UNUSUAL GRADING CONDITIONS ARE ENCOUNTERED DURING CONSTRUCTION.
- EROSION CONTROL: ALL GRADED SLOPES SHALL BE PLANTED WITH ROSEA ICE PLANT OR ANOTHER APPROVED GROUND COVER, AT TWELVE INCHES (12IN) ON CENTER. SLOPES OVER FIFTEEN FEET (15FT) IN VERTICAL HEIGHT, IN ADDITION TO GROUND COVER, SHALL BE PLANTED WITH APPROVED TREES, SHRUBS OR COMBINATION THEREOF. SHRUBS SHALL BE PLANTED AT TEN FEET (10FT) ON CENTER; TREES AT TWENTY FEET (20FT) ON CENTER; COMBINATIONS FIFTEEN FEET (15FT) ON CENTER. SLOPES OVER THREE FEET (3FT) IN VERTICAL HEIGHT SHALL HAVE PERMANENT IRRIGATION SYSTEMS WITH BACKFLOW PREVENTION DEVICES PER U.B.C.
- APPROVED PROTECTIVE MEASURES AND TEMPORARY DRAINAGE PROVISIONS MUST BE USED TO PROTECT ADJOINING PROPERTIES DURING THE GRADING PROJECT.
- APPROVED EROSION PREVENTIVE DEVICES SHALL BE PROVIDED AND MAINTAINED DURING THE RAINY SEASON AND SHALL BE IN PLACE AT THE END OF EACH DAY'S WORK.
- 28. ALL WORK SHALL CONFORM TO THE CITY AND STATE CONSTRUCTION SAFETY ORDERS.
- 29. THE LOCATION AND PROTECTION OF ALL UTILITIES IS THE RESPONSIBILITY OF THE PERMITTEE.
- 30. AN APPROVED SET OF GRADING PLANS SHALL BE ON THE JOB SITE AT ALL TIME.

PRIOR TO THE APPROVAL OF FINAL INSPECTION.

- SANITARY FACILITIES SHALL BE MAINTAINED ON THE SITE FROM BEGINNING TO COMPLETION OF
- GRADING OPERATION. 2. ALL SLOPES SHALL BE PLANTED AND IRRIGATION FACILITIES SHALL BE PROVIDED FOR ALL SLOPES IN EXCESS OF THREE (3) FEET VERTICAL HEIGHT WITHIN NINETY (90) DAYS AFTER COMPLETION OF ROUGH GRADING AND SHALL BE IN ACCORDANCE WITH CITY OF LAKE ELSINORE GRADING ORDINANCE NO. 882
- 33. ANY CONTRACTOR PERFORMING WORK ON THIS PROJECT SHALL FAMILIARIZE HIMSELF WITH THE SITE AND BE SOLELY RESPONSIBLE FOR ANY DAMAGE TO EXISTING FACILITIES RESULTING DIRECTLY OR INDIRECTLY FROM HIS OPERATIONS, WHETHER OR NOT SUCH FACILITIES ARE SHOWN ON THESE PLANS.
- . THE DESIGN ENGINEER SHALL PROVIDE A MINIMUM OF ONE (1) BLUE TOP PER FINISHED PAD, PRIOR TO ROUGH GRADE APPROVAL.
- 35. APPROXIMATE DATE OF: BEGINNING OPERATION: ____

36. NO ROCK OR OTHER IRREDUCIBLE MATERIAL WITH A MAXIMUM DIMENSION GREATER THAN THREE INCHES (3IN) WILL BE PLACED IN FILLS WITHIN ROADBED AREAS OR THREE FEET (3FT) OF FINISH GRADES, UNLESS THE LOCATION, MATERIALS, AND DISPOSAL METHODS ARE SPECIFICALLY APPROVED BY THE SOILS ENGINEER.

- A PERMIT SHALL BE OBTAINED FROM THE ENGINEERING DEPARTMENT, CITY OF LAKE ELSINORE, PRIOR 37. THE ENGINEER MUST SET GRADE STAKES FOR ALL DRAINAGE DEVICES AND OBTAIN INSPECTION BEFORE
- THE DEVELOPER AND/OR THE CONTRACTOR SHALL NOTIFY ALL UTILITY COMPANIES AND U.S.A. ALERT 38. GRADING PLANS WILL NOT BE APPROVED UNTIL ALL RETAINING WALLS ARE APPROVED BY THE BUILDING DEPARTMENT.
 - 39. THIS SITE HAS OBTAINED A NATIONAL POLLUTION PREVENTION ELIMINATION SYSTEM (NPDES) PERMIT TO REGULATE MUNICIPAL AND INDUSTRIAL STORM WATER DISCHARGES. NPDES WDID #______ DATE PERMIT ISSUED: _____
 - 40. DRAINAGE EASEMENTS WILL BE KEPT CLEAR OF ALL OBSTRUCTIONS. NO BUILDINGS OR WALLS SHALL BE PLACED WITHIN EASEMENT LIMITS. TEMPORARY IMPROVEMENTS ARE SUBJECT TO REMOVAL AT OWNER'S EXPENSE

EROSION CONTROL NOTES

ALL EROSION CONTROL PLANS SHALL BE IN ACCORDANCE WITH CITY OF LAKE ELSINORE ORDINANCE NOS.1237, 772, 529, 1004, CONSTRUCTION SITE BEST MANAGEMENT PRACTICES (BMP'S) AND STANDARDS OUTLINED WITHIN THE LAKE ELSINORE DESIGN MANUAL. NO GRADING PERMIT SHALL BE ISSUED WITHOUT AN EROSION CONTROL PLAN APPROVED BY THE CITY ENGINEER. THE EROSION CONTROL PLAN SHALL INCLUDE DETAILS OF PROTECTIVE MEASURES, INCLUDING DESILTING BASINS OR OTHER TEMPORARY DRAINAGE OR CONTROL MEASURES, OR BOTH, AS MAY BE NECESSARY TO PROTECT THE WATER QUALITY OF RECEIVING WATER BODIES OR TO PROTECT ADJOINING PUBLIC AND PRIVATE PROPERTY FROM DAMAGE FROM EROSION, FLOODING OR THE DEPOSITION OF MUD OR DEBRIS WHICH MAY ORIGINATE FROM THE SITE OR RESULT FROM SUCH GRADING OPERATIONS. THE FOLLOWING EROSION CONTROL AND NPDES NOTES AS WORDED WITH BLANKS FILLED IN, SHALL BE PLACED ON THE PLANS:

- FINISH GRADE SHALL BE SLOPED AWAY FROM ALL EXTERIOR WALLS AT NOT LESS THAN 1/2 THE PER FOOT 1. ALL EROSION CONTROL PLANS SHALL BE IN ACCORDANCE WITH CITY OF LAKE ELSINORE ORDINANCE NOS. 529, 772, 1237, 1004, CONSTRUCTION SITE BEST MANAGEMENT PRACTICES (BMP'S), AND STANDARDS OUTLINED WITHIN THE LAKE ELSINORE DESIGN MANUAL.
 - 2. THE DEVELOPER/CONTRACTOR IS RESPONSIBLE FOR ANY DISCHARGES BY SUBCONTRACTORS.
 - (RESPONSIBLE PERSON) AT _ (24-HOUR PHONE NUMBER).
 - 4. DEVICES TO REDUCE EROSION DAMAGE SHALL NOT BE PLACED MOVED OR MODIFIED WITHOUT THE APPROVAL OF THE QUALIFIED SWPPP DEVELOPER, CITY ENGINEER, OR IN AN EMERGENCY, BY THE PERSON RESPONSIBLE FOR GRADING OPERATIONS.
 - 5. AREAS THAT ARE CLEARED AND GRADED SHALL BE LIMITED TO ONLY THE PORTION OF THE SITE THAT IS NECESSARY FOR CONSTRUCTION. THE CONSTRUCTION SITE SHALL BE MANAGED TO MINIMIZE THE EXPOSURE TIME OF DISTURBED SOIL AREAS THROUGH PHASING AND SCHEDULING OF GRADING AND THE USE OF TEMPORARY AND PERMANENT SOIL STABILIZATION.
 - ONCE DISTURBED, GRADED SLOPES EXCEEDING A 3:1 RATIO AND/OR TEN (10) FEET IN HEIGHT (TEMPORARY OR PERMANENT) SHALL BE STABILIZED IF THEY WILL NOT BE WORKED WITHIN 7 DAYS. DURING THE STORM SEASON, ALL SLOPES SHALL BE STABILIZED 24 HOURS PRIOR TO A PREDICTED STORM EVENT. CONSTRUCTION SITES SHALL BE REVEGETATED AS EARLY AS FEASIBLE AFTER SOIL DISTURBANCE AND WITHIN 7-DAYS OF COMPLETION.
 - 7. FILL SLOPES AT THE TRACT PERIMETER MUST DRAIN AWAY FROM THE TOP OF THE SLOPE AT THE CONCLUSION OF EACH WORKING DAY.
 - 8. THE CONTRACTOR SHALL BE RESPONSIBLE AND HAVE SIGNS POSTED ON THE SITE TO WARN AGAINST PUBLIC TRESPASS INTO AREAS WHERE WATER IS IMPOUNDED.
 - 9. DUST SHALL BE CONTROLLED BY WATERING OR OTHER METHODS APPROVED BY THE CITY ENGINEER.
 - 10. PLACEMENT OF DEVICES TO REDUCE EROSION DAMAGE WITHIN THE DEVELOPMENT SHALL BE SHOWN ON THE APPROVED PLAN.
 - TWENTY-FIVE (25) YEAR, SIX (6) HOUR STORM INTENSITY. THEY MUST BE DETAILED ON THE PLANS. DESIGN AND SPECIFIC RECOMMENDATIONS SHALL BE SUBMITTED FOR THE FOLLOWING: A) DESILTING BASIN VOLUME BASED ON GRADIENT AND NATURE OF SOILS. B) THE EXTENT OF ALL GRADED AREAS AND IDENTIFICATION OF ANY TEMPORARY SOIL STABILIZATION MEASURES. C) SIZE OF DESILTING BASIN OUTLET PIPE AND OVERFLOW. D) DIKE REQUIREMENTS. SHOW MINIMUM WALL WIDTH, SLOPE OF WALLS, PERCENT COMPACTION, ETC. E) OUTLET CONDITIONS FROM THE DESILTING BASIN SHALL NOT EXCEED DOWNSTREAM LIMITATIONS, WITH THE EXCEPTION OF OVERFLOW, WHICH IS TO BE DESIGNED TO PROVIDE CAPACITY OF 1.5 TIMES THE MAXIMUM DESIGN FLOW.
 - 12. NECESSARY MATERIALS SHALL BE AVAILABLE ON-SITE AND AT CONVENIENT LOCATIONS TO FACILITATE RAPID CONSTRUCTION OF TEMPORARY DEVICES OR TO REPAIR ANY DAMAGED EROSION CONTROL MEASURES WHEN A 50% CHANCE OR GREATER OF RAIN WITHIN A 48 HOUR PERIOD IS FORECAST FOR LAKE ELSINORE BY THE NATIONAL OCEANIC AND ATMOSPHERIC AGENCY (NOAA).
 - 13. BMPS SHALL BE MAINTAINED AND INSPECTED DAILY TO MINIMIZE AND/OR PREVENT THE ENTRAINMENT OF SOIL IN RUNOFF FROM DISTURBED SOIL AREAS ON CONSTRUCTION SITES. ALL REMOVABLE PROTECTIVE EROSION CONTROL DEVICES SHOWN SHALL BE IN PLACE AT THE END OF EACH WORKING DAY WHEN THE FOUR (4) DAY RAIN PROBABILITY FORECAST EXCEEDS FORTY PERCENT (40%).
 - 14. AFTER A RAINSTORM, ALL PROJECT GENERATED SILT AND DEBRIS SHALL BE REMOVED FROM CHECK BERMS, ONSITE PUBLIC DRAINS AND PIPES, DRAINS AND PIPES OF ADJACENT PROPERTIES AND DESILTING BASINS AND THE BASINS PUMPED DRY. ANY GRADED SLOPE BMP'S DAMAGED DURING A RAINSTORM SHALL ALSO BE IMMEDIATELY REPAIRED. FAILURE TO PROVIDE EFFECTIVE MAINTENANCE MAY RESULT IN PENALTIES.
 - 15. DISCHARGING OF CONTAMINATED SOILS VIA SURFACE EROSION IS PROHIBITED.
 - 16. CONSTRUCTION ACCESS POINTS SHALL BE STABILIZED WITH A COMBINATION OF ROCK AND SHAKER PLATES YEAR-ROUND TO PREVENT TRACK-OUT. ROUTINE STREET SWEEPING SHALL BE PERFORMED ON ALL PAVED STREETS WHERE TRACKING IS OBSERVED. VACUUM SWEEPERS SHALL BE USED WHEN STREET SWEEPING BECOMES INEFFECTIVE.

NPDES / STORM WATER POLLUTION NOTES

- 1. FOR PROJECTS THAT REQUIRE COVERAGE UNDER THE GENERAL CONSTRUCTION PERMIT, THE PROPERTY OWNER IS RESPONSIBLE FOR ENSURING THAT A QUALIFIED SWPPP PRACTITIONER (QSP) AND QUALIFIED SWPPP DEVELOPER (QSD) IMPLEMENT AND MAINTAIN THE SWPPP-APPROVED, PRE-QUALIFIED BMPS FROM THE CALIFORNIA STORM WATER QUALITY ASSOCIATION (CASQA) HANDBOOK / WEBSITE FOR CONSTRUCTION TO RETAIN SEDIMENTS AND POLLUTANTS OF CONCERN FROM AREAS DISTURBED ONSITE EXTENT PRACTICABLE DURING ANY PHASE OF CONSTRUCTION OPERATIONS. FOR ALL OTHER PROJECTS, THE PROPERTY OWNER IS RESPONSIBLE FOR ENSURING THAT BMPS FOR CONSTRUCTION ARE IMPLEMENTED TO RETAIN SEDIMENTS AND POLLUTANTS OF CONCERN FROM AREAS DISTURBED ONSITE TO THE MAXIMUM EXTENT PRACTICABLE. THE EROSION CONTROL MEASURES INCLUDE THOSE SHOWN ON THIS PLAN AS WELL AS ANY ADDITIONAL EROSION CONTROL MEASURES DICTATED BY FIELD CONDITIONS TO PREVENT EROSION AND/OR THE INTRODUCTION OF POLLUTANTS INTO EXISTING PUBLIC STREETS AND/OR ONTO ADJACENT PROPERTIES DURING ANY PHASE OF CONSTRUCTION.
- 2. FOR PROJECTS THAT REQUIRE COVERAGE UNDER THE GENERAL CONSTRUCTION PERMIT, THE STORM WATER POLLUTION PREVENTION PLAN (SWPPP) SHALL BE KEPT ON-SITE AND MADE AVAILABLE UPON REQUEST OF A REPRESENTATIVE OF THE REGIONAL WATER QUALITY CONTROL BOARD (RWQCB) -SANTA ANA REGION AND/OR THE CITY OF LAKE ELSINORE.
- CONSTRUCTION SITES SHALL BE MAINTAINED IN SUCH A CONDITION THAT AN ANTICIPATED STORM DOES NOT CARRY WASTES OR POLLUTANTS OFF THE SITE. DISCHARGES OF MATERIAL OTHER THAN STORM WATER (NON-STORM WATER) ARE PROHIBITED EXCEPT AS AUTHORIZED BY AN INDIVIDUAL

THIS SURVEY AND EASEMENTS SHOWN HEREON ARE BASED ON INFORMATION CONTAINED IN THE PRELIMINARY TITLE REPORT PREPARED BY:

FIRST AMERICAN TITLE INSURANCE COMPANY 4380 LA JOLLA VILLAGE DRIVE, SUITE 110 SAN DIEGO, CA 92122

(858) 410-2151 COMMITMENT NUMBER: NCS-882366-SD COMMITMENT DATE: NOVEMBER 27, 2017 TITLE OFFICER: TRIXY BROWN / JANICE TREANOR

EASEMENT NOTES **

REFER TO TITLE REPORT FOR ADDITIONAL INFORMATION AND DETAILS:

- ABUTTER'S RIGHTS OF INGRESS AND EGRESS TO OR FROM FREEWAY HAVE BEEN RELINQUISHED IN THE DOCUMENT RECORDED OCTOBER 10, 1978 AS INSTRUMENT NO. 213000 OF OFFICIAL RECORDS
- NOTE: SAID DOCUMENT ACCOUNTS FOR A PORTION OF RELINQUISHED ACCESS RIGHTS AS SHOWN ON THE SURVEY. RELINQUISHED ACCESS RIGHTS ALONG THE WESTERLY PARCEL 1 (R1) LINE ARE SHOWN PER CALTRANS MAP (R3).
- AN EASEMENT FOR PUBLIC UTILITIES AND INCIDENTAL PURPOSES, RECORDED APRIL 16, 2008 AS INSTRUMENT NO. 2008-0189715 OF OFFICIAL RECORDS. SOUTHERN CALIFORNIA EDISON COMPANY, A CORPORATION, ITS SUCCESSORS AND ASSIGNS

AS DESCRIBED THEREIN

- NOTE: THE LAST COURSE OF STRIP NO. 4 IN SAID DOCUMENT APPEARS TO BE IN ERROR. THE COURSE OF NORTH 43°43'52" EAST IS PLOTTED HEREON INSTEAD OF NORTH 43°43'52" WEST AS STATED IN THE DOCUMENT, IN ORDER TO ALIGN WITH THE GIVEN DISTANCE AND CONNECTED TO STRIP NO. 5. PER THE DOCUMENT. ALSO AN EXISTING ELECTRICAL VAULT IS LOCATED OUTSIDE OF STRIP NO. 5 ALONG DEXTER PLACE.
- THE TERMS, PROVISIONS AND EASEMENT(S) CONTAINED IN THE DOCUMENT ENTITLED "FREEWAY SIGN EASEMENT AGREEMENT" RECORDED APRIL 18, 2008 AS INSTRUMENT NO. 2008-0195591 OF OFFICIAL RECORDS.

NOTE: THE EXACT LOCATION OF THE FREEWAY SIGN EASEMENT CANNOT BE DETERMINED

FROM THE RECORD DOCUMENT. THE SHOPPING CENTER FREEWAY PYLON SIGN IS

- LOCATED AT WESTERLY CORNER AS SHOWN ON THE SURVEY. AN EASEMENT FOR PUBLIC STREET AND INCIDENTAL PURPOSES, RECORDED
- OCTOBER 09, 2008 AS INSTRUMENT NO. 2008-0546334 OF OFFICIAL RECORDS. IN FAVOR OF: CITY OF LAKE ELSINORE, A MUNICIPAL CORPORATION, ITS SUCCESSORS AND ASSIGNS AS DESCRIBED THEREIN
- AN OFFER OF DEDICATION FOR RIGHT OF WAY AND INCIDENTAL PURPOSES, RECORDED OCTOBER 09, 2008 AS INSTRUMENT NO. 2008-0546335 OF OFFICIAL RECORDS. REQUIRED BASED ON SITE RISK LEVEL OR AS MANDATED BY THE SANTA ANA REGIONAL BOARD NPDES

CITY OF LAKE ELSINORE, A MUNICIPAL CORPORATION, ITS SUCCESSORS AND ASSIGNS

ITEM(S) BELOW IS NOT LISTED IN THE SUBJECT TITLE REPORT LISTED HEREON:

 $\langle \overline{A} \rangle$ = PROPOSED 15 FOOT PUBLIC STORM DRAIN EASEMENT, SHOWN PER CITY OF LAKE ELSINORE GRADING PLAN FOR LONESTAR STEAK HOUSE DATED NOV. 2007.

LEGAL DESCRIPTION **

REAL PROPERTY IN THE CITY OF LAKE ELSINORE, COUNTY OF RIVERSIDE, STATE OF CALIFORNIA, DESCRIBED AS FOLLOWS:

PARCEL 1 AS SHOWN ON NOTICE OF LOT LINE ADJUSTMENT NO. 2007-12, AS EVIDENCED BY DOCUMENT RECORDED ON MARCH 18, 2008 AS INSTRUMENT NO. 2008-000131995, OF OFFICIAL RECORDS, BEING MORE DESCRIBED AS FOLLOWS:

THAT PORTION OF PARCEL 3 & 4 ON RECORD OF SURVEY ON FILE IN BOOK 42, PAGE 61 OF RECORDS OF SURVEY, RECORDS OF RIVERSIDE COUNTY, CALIFORNIA.


TOGETHER WITH THAT PORTION OF DEXTER AVENUE ABUTTING SAID LAND AND LYING BETWEEN THE NORTHERLY PROLONGATION OF THE NORTHWESTERLY AND THE SOUTHEASTERLY BOUNDARIES OF SAID LAND AS CONTAINED IN RESOLUTION RECORDED MAY 11, 1990 AS INSTRUMENT NO. 174610 OF OFFICIAL RECORDS.

EXCEPT THEREFROM THAT PORTION AS CONVEYED TO THE STATE OF CALIFORNIA BY DEED RECORDED OCTOBER 10, 1978 AS INSTRUMENT NO. 213000, OFFICIAL RECORDS.

BEGINNING AT THE CENTERLINE INTERSECTION OF DEXTER AVENUE AND THIRD

AVENUE (OLD ALIGNMENT) AS SHOWN ON A CALTRANS RIGHT OF WAY MAP NO. 916532, RECORDS OF CALTRANS, DISTRICT NO. 8, SHOWING THIS AREA WITHIN THE CITY OF ELSINORE AREA, COUNTY OF RIVERSIDE, STATE OF CALIFORNIA. THENCE NORTH 46° 13' 18" WEST ALONG THE CENTERLINE OF DEXTER AVENUE A DISTANCE OF 246.44 FEET THENCE SOUTH 43° 46' 11" WEST 30.00 FEET TO THE NORTHEAST CORNER OF SAID PARCEL 3; THENCE NORTH 46° 13' 18" WEST 103.73 FEET ALONG SOUTHERLY RIGHT OF WAY OF DEXTER AVENUE 30 FEET WIDE AS IT NOW EXIST TO A NON-TANGENT CURVE CONCAVE NORTHEASTERLY WITH A RADIUS OF 330.00 FEET, A RADIAL LINE THROUGH SAID POINT BEAR NORTH 43° 46' 42" EAST; THENCE NORTHWESTERLY ALONG SAID CURVE THROUGH A CENTRAL ANGLE OF 12° 43' 37". AN ARC DISTANCE OF 73.08 FEET TO THE TRUE POINT OF BEGINNING THENCE SOUTH 57° 36' 58" WEST 34.72 FEET; THENCE SOUTH 43° 45' 11" WEST 142.98 FEET; THENCE SOUTH 58° 46' 55" WEST 49.49 FEET TO THE SOUTH WESTERLY LINE OF SAID PARCEL 3 THENCE NORTH 31° 49' 10" WEST 223.51 FEET; THENCE NORTH 43° 45' 11" EAST 150.84 FEET; THENCE NORTH 43° 43' 52" EAST 27.42 FEET TO A POINT ON THE SOUTHERLY RIGHT OF WAY OF DEXTER PLACE 30.00 FEET WIDE AS IT NOW EXIST SAID POINT ON A NON-TANGENT CURVE, CONCAVE SOUTHEASTERLY, WITH A RADIUS OF 190.00 FEET, A RADIAL LINE THROUGH SAID POINT BEAR NORTH 19° 03' 05" EAST; THENCE NORTHEASTERLY ALONG SAID CURVE THROUGH A CENTRAL ANGLE OF 27° 04' 33", AN ARC DISTANCE OF 89.79 FEET: THENCE NORTH 81° 58' 32" EAST 5.93 FEET; THENCE NORTH 53° 01' 28" WEST 21.21 FEET TO THE WESTERLY RIGHT OF WAY OF DEXTER AVE THENCE SOUTH 08° 01' 28" EAST 14.60 FEET TO A NON TANGENT CURVE, CONCAVE SOUTHEASTERLY, WITH A RADIUS OF 330.00 FEET, A RADIAL LINE THROUGH SAID POINT BEAR NORTH 81° 58' 32" EAST THENCE SOUTHERLY ALONG SAID CURVE THROUGH A CENTRAL ANGLE OF 25° 30' 13", AN ARC DISTANCE OF 146.92 FEET TO THE TRUE POINT OF BEGINNING.

APN: 377-080-084-7

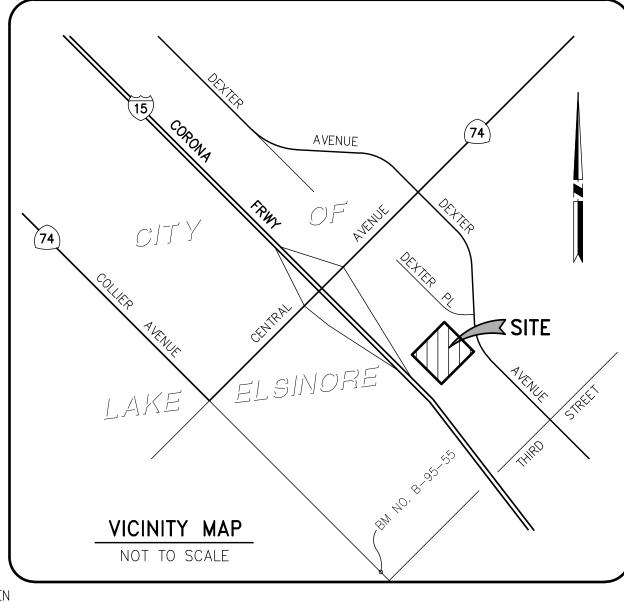

TITLE SHEET

THIS PLAN IS:

(NOT FOR CONSTRUCTION)

CONCEPTUAL GRADING PLAN CONSTRUCTION NOTES


CONCEPTUAL UTILITY PLAN

* FOR REFERENE ONLY

ALTA SURVEY (TITLE SHEET) — ALTA SURVEY (TOPO)

NOTICE TO CONTRACTOR

THE CONTRACTOR SHALL ASCERTAIN THE TRUE VERTICAL AND HORIZONTAL LOCATION AND SIZE OF ALL UTILITIES, PIPES, AND/OR STRUCTURES AND SHALL BE RESPONSIBLE FOR DAMAGE TO ANY PUBLIC OR PRIVATE UTILITIES, SHOWN OR NOT SHOWN HEREON.

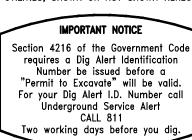

SOURCE OF BOUNDARY & EASEMENT INFORMATION. **

THE TOPOGRAPHIC INFORMATION SHOWN ON THESE PLANS WERE TAKEN FROM THE PLAN REFERENCED BELOW.

DATE OF SURVEY: JANUARY 04, 2018

ALTA SURVEY BY: TRUXAW AND ASSOCIATES, INC. 265 S. ANITA DR., SUITE 111 ORANGE, CA 92868 (714) 935-0265 JOB # CFA06105

DEVELOPER

CHICK-FIL-A

5200 BUFFINGTON ROAD ATLANTA, GEORGIA 30349

ARCHITECT

CRHO ARCHITECTS

195 SOUTH "C" STREET, SUITE 200 TUSTIN, CA 92780 (714) 832-1834 FAX (714) 832-1910

SOILS ENGINEER

THESE PLANS HAVE BEEN DESIGNED IN ACCORDANCE WITH THE GEOTECHNICAL RECOMMENDATIONS MADE BY:

GILES ENGINEERING ASSOCIATES, INC. 1965 NORTH MAIN STREET

ORANGE, CA 92865 PH (714) 279-0817 FAX (714) 279-9687 PROJECT No. 2G-1712003

REPORT DATE: JANUARY 23, 2018 CONTRACTOR SHALL OBTAIN A COPY OF THIS REPORT AND ALL ADDENDUM AND FOLLOW THE RECOMMENDATIONS THEREIN. NOTIFY TRUXAW AND ASSOCIATES OF ANY

DISCREPANCIES OR FIELD CHANGES PRIOR TO CONSTRUCTION.

DATE

SIGNATURE - SOILS ENGINEER






Atlanta Georgia, 30349-2998

Revisions: Mark Date By

lMark Date By

Mark Date By



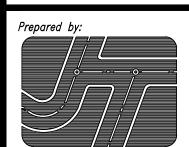

JOSEPH C. TRUXAW & ASSOCIATES, INC.

> Civil Engineers and Land Surveyors 265 S. ANITA DRIVE. SUITE 11 ORANGE, CA 92868 (714) 935-0265 (714) 935-0106 (FAX)

STORE

CENTRAL AVENUE & DEXTER AVENUE


LAKE ELSINORE, CALIFORNIA

SHEET TITLE TITLE SHEET

VERSION: ISSUE DATE:

Job No. : <u>CFA0610</u> : <u>#</u>04261 Store . 03-07-1 Date

Drawn By Checked By: SMH

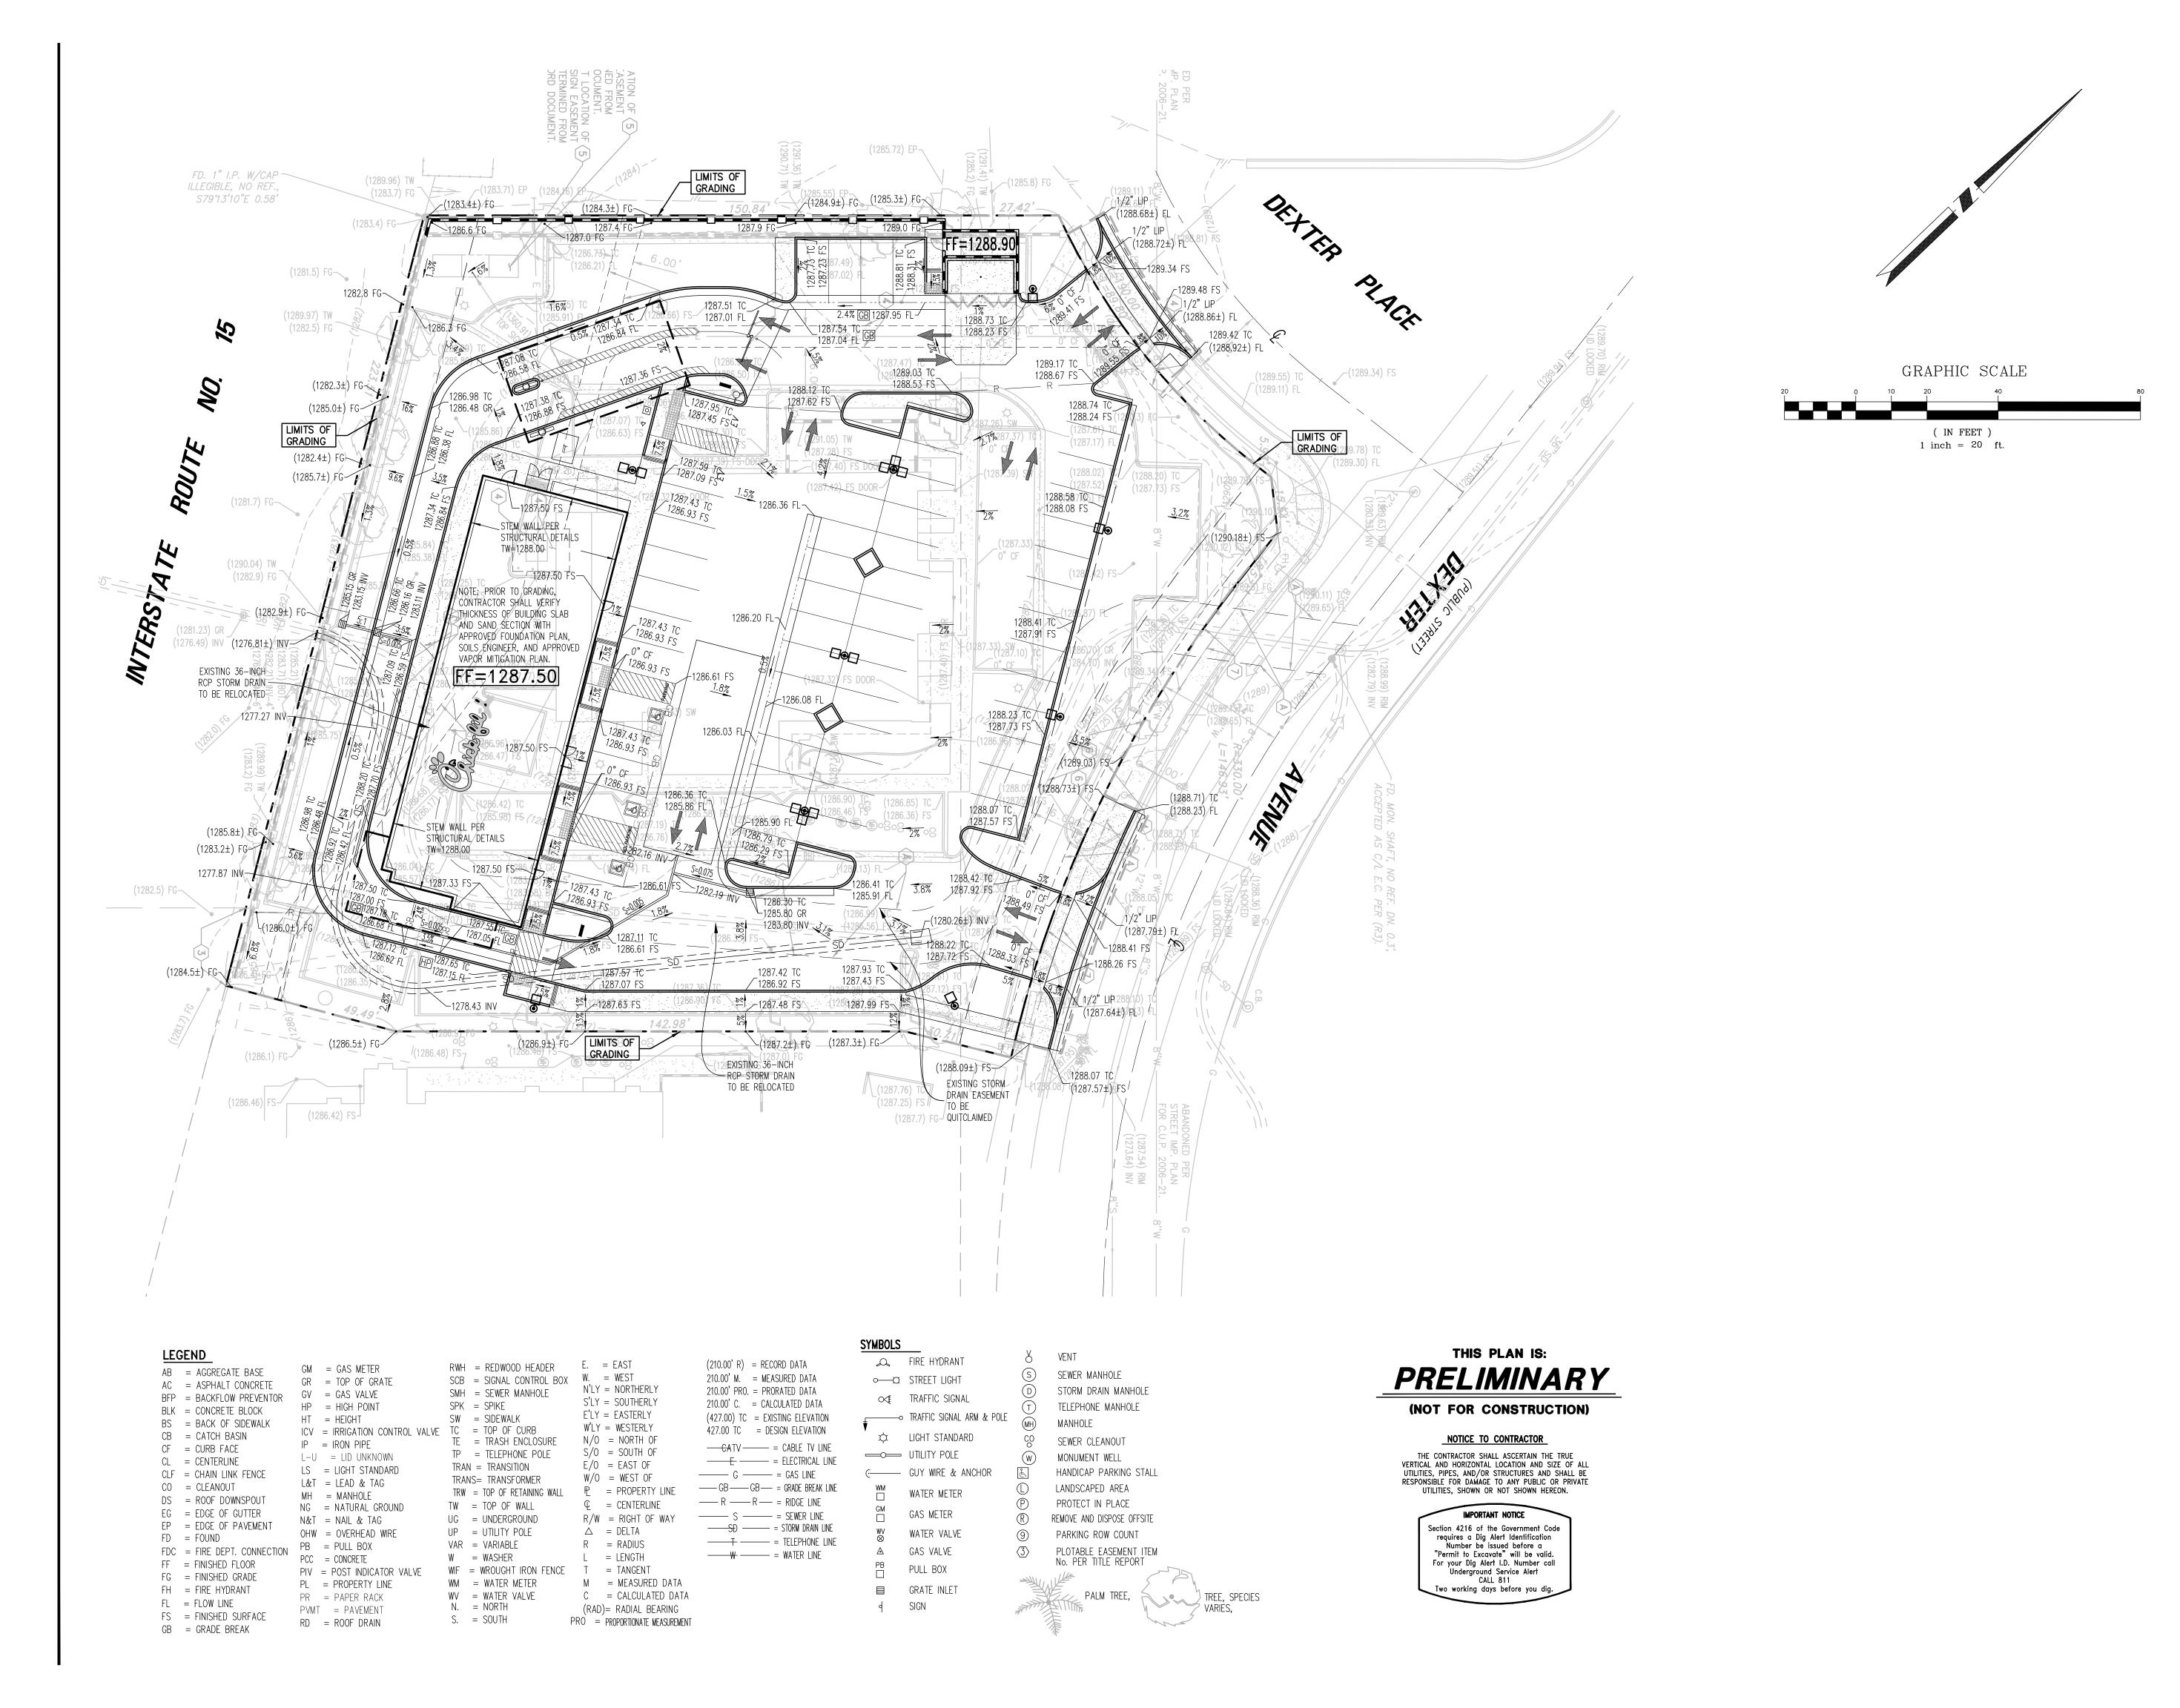





Atlanta Georgia, 30349—2998


Revisions:

Mark Date By

Mark Date By ∧

Mark Date By ∧



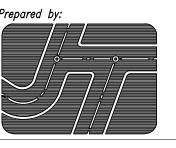

JOSEPH C. TRUXAW & ASSOCIATES, INC.

Civil Engineers and Land Surveyors 265 S. ANITA DRIVE, SUITE 11 ORANGE, CA 92868 (714) 935-0265 (714) 935-0106 (FAX)

STORE CENTRAL

CENTRAL AVENUE & DEXTER AVENUE

LAKE ELSINORE, CALIFORNIA

SHEET TITLE
CONCEPTUAL
GRADING
PLAN


VERSION: ISSUE DATE:

Job No. : <u>CFA0610</u>
Store : <u>#04261</u>
Date : <u>03-07-1</u>
Drawn By : <u>MME/G</u>

Checked By: SMH

Sheet

of 4

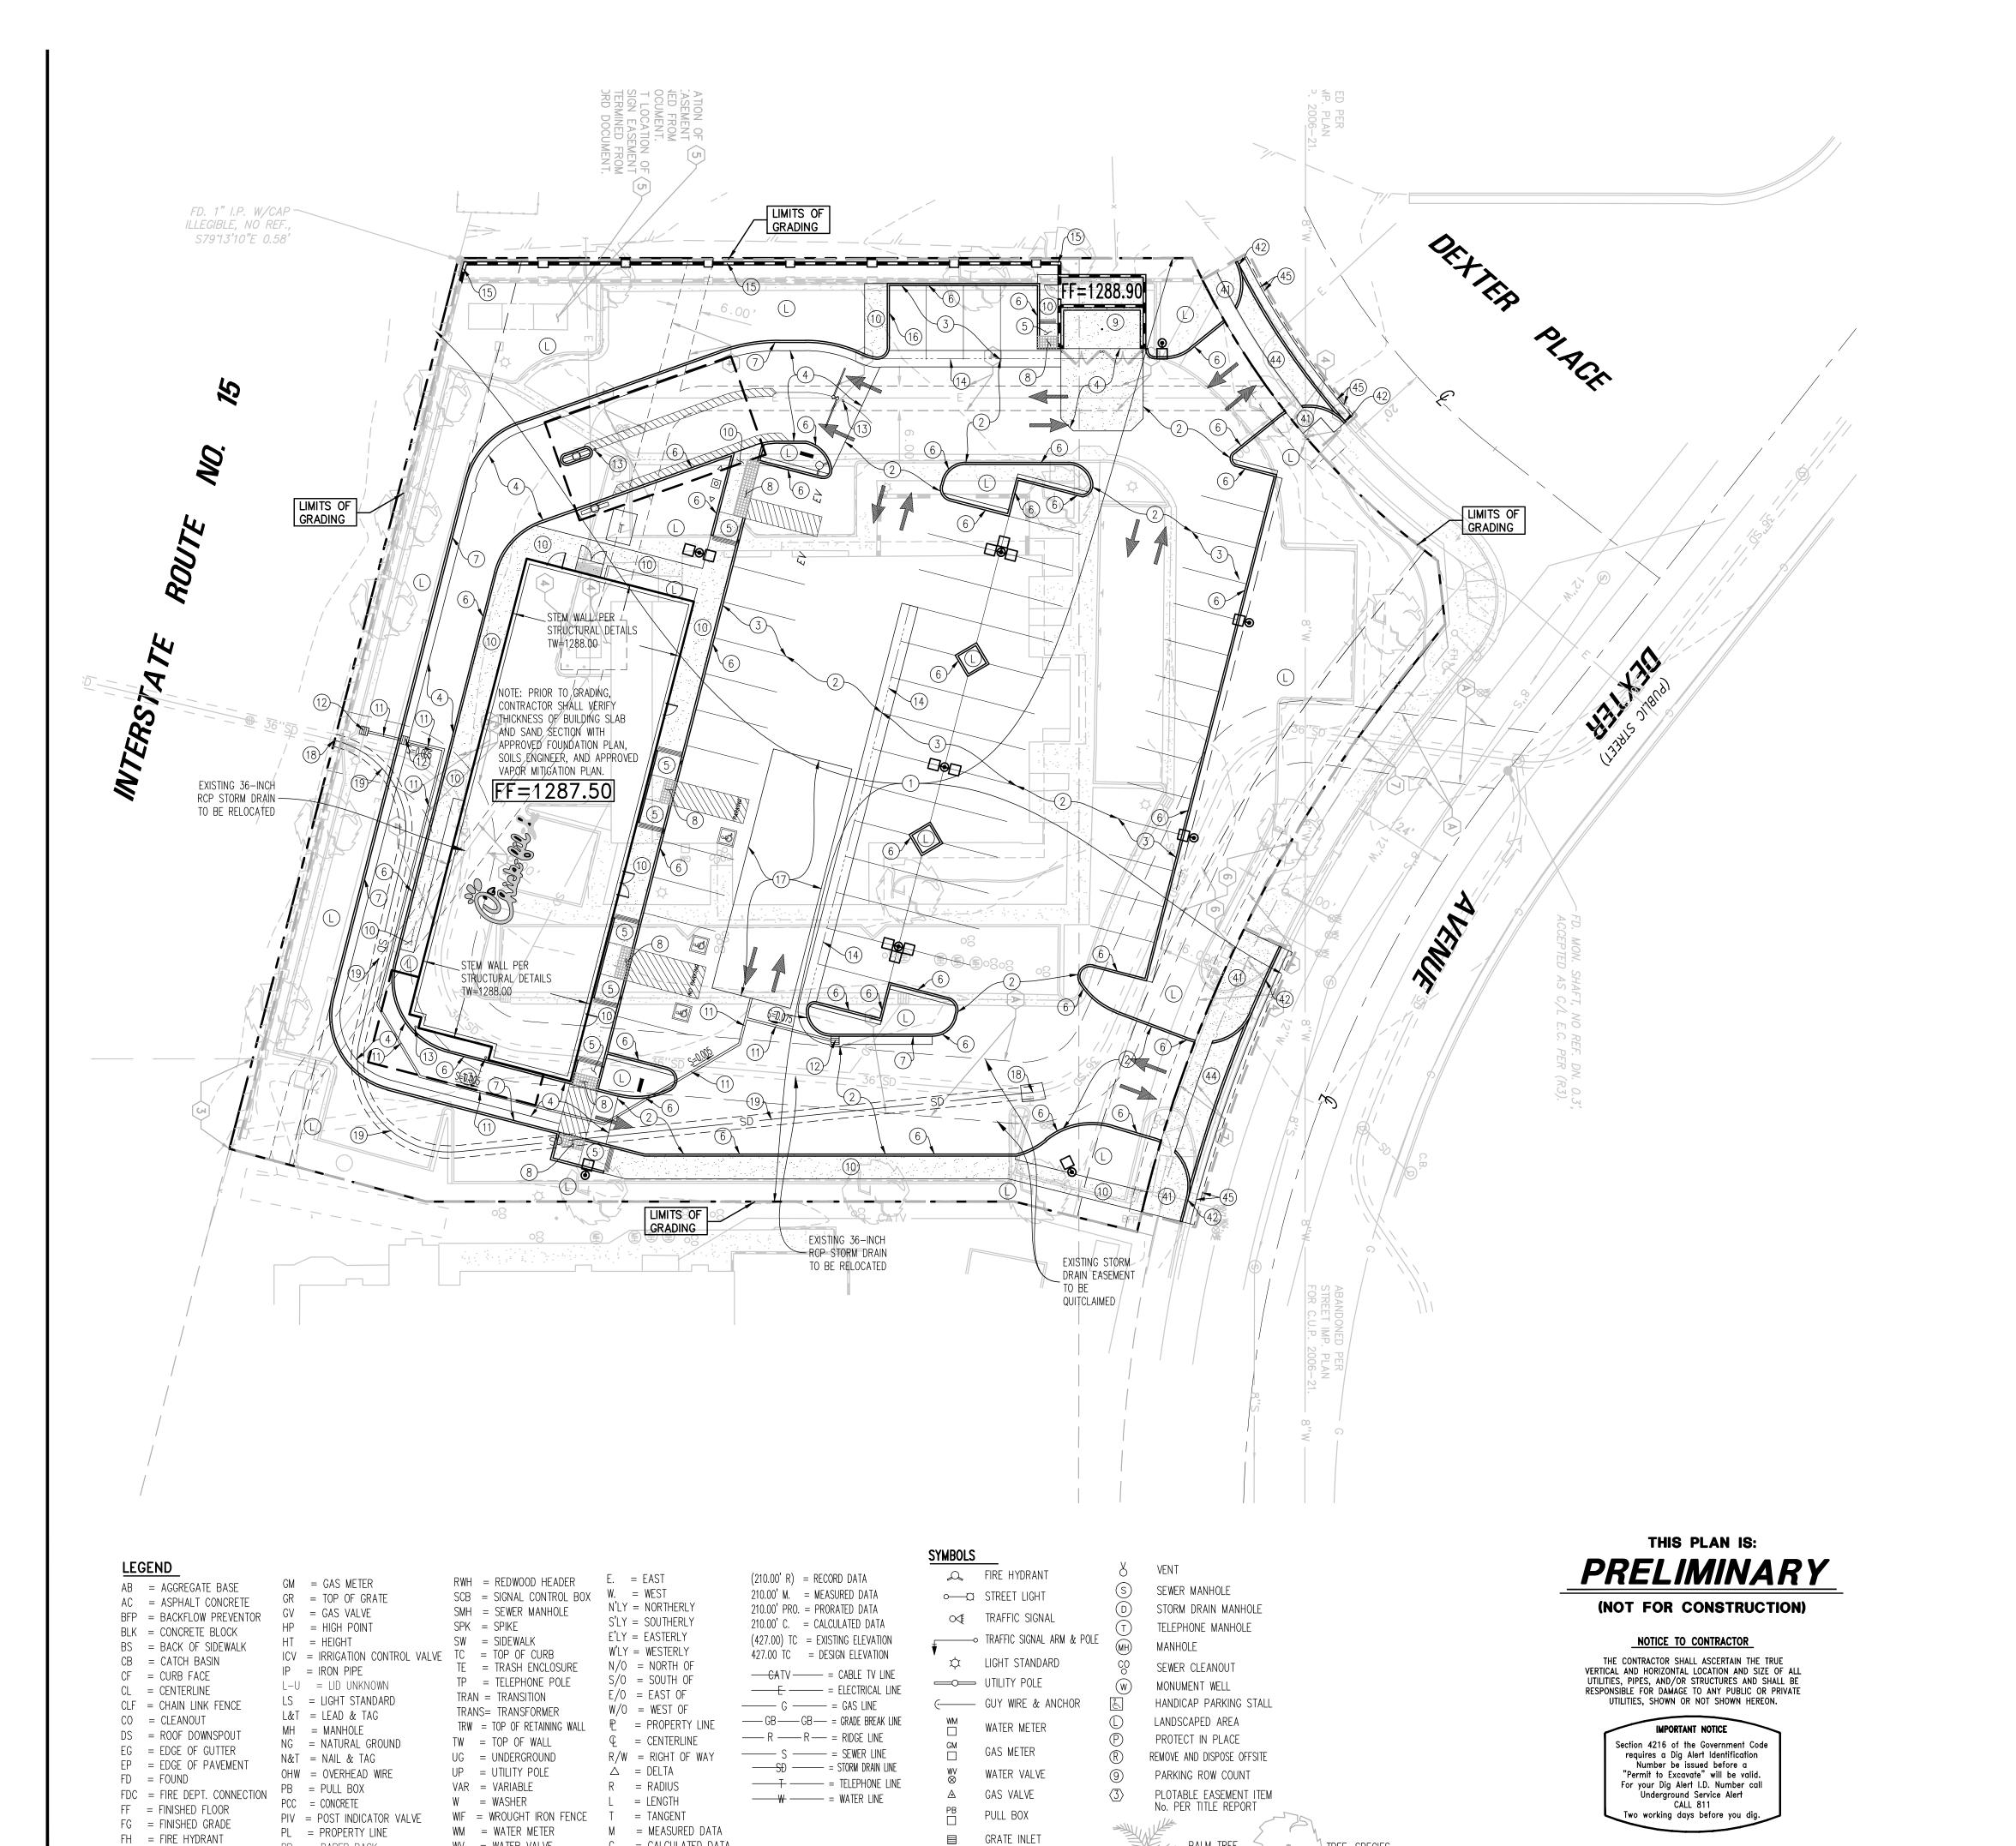

SIGN

C = CALCULATED DATA

(RAD)= RADIAL BEARING

PRO = PROPORTIONATE MEASUREMENT

WV = WATER VALVE

N. = NORTH

S. = SOUTH

PR = PAPER RACK

PVMT = PAVEMENT

RD = ROOF DRAIN


FL = FLOW LINE

FS = FINISHED SURFACE

GB = GRADE BREAK

PALM TREE, SPECIES



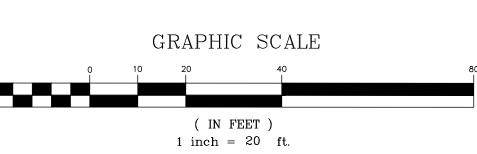

CONSTRUCTION NOTES

- (1) SAWCUT & REMOVE EXIST. AC PAVING, CONCRETE CURB, ETC.
- PAVE WITH 3-INCHES AC OVER 8-INCHES AB OVER COMPACTED SUBGRADE (DRIVE LANES).
- PAVE WITH 3-INCHES AC OVER 5-INCHES AB OVER COMPACTED SUBGRADE (PARKING STALLS). *** 4 PAVE WITH 6-INCHES PCC OVER 4-INCHES AB OVER COMPACTED SUBGRADE.
- 5 CONSTRUCT CONCRETE ACCESSIBLE RAMP IN ACCORDANCE WITH CA TITLE 24 REQUIREMENTS, ADA GUIDELINES, CITY STANDARDS AND ARCHITECTURAL DETAILS.
- (6) CONSTRUCT CONCRETE CURB. (6-INCH CURB HEIGHT UNLESS SHOWN OTHERWISE.)
- (7) CONSTRUCT 6-INCH CURB & 24-INCH GUTTER.
- (8) PLACE TRUNCATED DOMES PER ADA REQUIREMENTS.
- TRASH ENCLOSURE, CONCRETE APRON AND STORAGE ROOM
- PER ARCHITECTURAL DETAILS (UNDER SEPARATE PLAN CHECK AND PERMIT).
- (10) CONSTRUCT CONCRETE SIDEWALK.
- PLACE ____-INCH SDR-35 STORM DRAIN PIPE WITH ALL NECESSARY FITTINGS AND ADAPTERS. PIPE BEDDING AND BACKFILL TO CONFORM WITH THE RECOMMENDATIONS OF THE SOILS ENGINEER.
- (12) PLACE 24" X 24" GRATED INLET.
- 13) PLACE BOLLARD.
- 14) CONSTRUCT CONCRETE 48-INCH GUTTER.
- RETAINING WALL PER STRUCTURAL PLANS.
- CONSTRUCT 4-INCH ROLLED CONCRETE CURB PER CITY OF LAKE ELSINORE STD. NO. 205 AND TRANSITION PER STD. NO. 206.
- (17) install underground infiltration unit.
- (18) CONNECT TO EXISTING 36-INCH RCP STORM DRAIN WITH CONCRETE COLLAR.
- PLACE 36-INCH RCP STORM DRAIN PIPE WITH ALL NECESSARY FITTINGS AND ADAPTERS. PIPE BEDDING AND BACKFILL TO CONFORM WITH THE RECOMMENDATIONS OF THE SOILS ENGINEER.
- (L) LANDSCAPE

*** PAVEMENT DESIGN SECTIONS PER THE RECOMMENDATIONS OF THE SOILS ENGINEER.

OFFSITE **

- (40) SAWCUT AND REMOVE CONCRETE SIDEWALK, CURB, PAVEMENT, ETC.
- CONSTRUCT CONCRETE SIDEWALK (MATCH EXISTING IN KIND)
- CONSTRUCT CURB AND GUTTER PER CITY OF LAKE ELSINORE STDS. (MATCH EXISTING IN KIND)
- (43) TRENCHING AND PAVING PER CITY OF LAKE ELSINORE REQUIREMENTS.
- (44) CONSTRUCT DRIVEWAY PER CITY OF LAKE ELSINORE STANDARD.
- (45) PATCH FULL-DEPTH AC PAVEMENT (8-INCH MINIMUM THICKNESS)
- ** CONTRACTOR TO APPLY FOR AND OBTAIN ENCROACHMENT PERMIT FOR IMPROVEMENTS WITHIN PUBLIC R/W

DISPOSITION NOTES

- P = PROTECT IN PLACE
- R = REMOVE AND DISPOSE OF OFFSITE
- $\bigcirc A$ = ADJUST TO GRADE
- RE = RELOCATE






Atlanta Georgia, 30349-2998

Revisions: Mark Date By

Mark Date By

Mark Date By



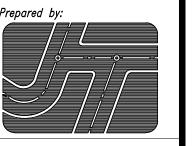

JOSEPH C. TRUXAW & ASSOCIATES, INC.

Civil Engineers and Land Surveyors 265 S. ANITA DRIVE, SUITE 11 ORANGE, CA 92868 (714) 935-0265 (714) 935-0106 (FAX)

STORE

CENTRAL AVENUE & DEXTER AVENUE


LAKE ELSINORE, CALIFORNIA

SHEET TITLE CONSTRUCTION


VERSION: ISSUE DATE:

Job No. : <u>CFA0610</u> : <u>#</u>04261 Store . 03-07-1 Date

Drawn By Checked By: SMH

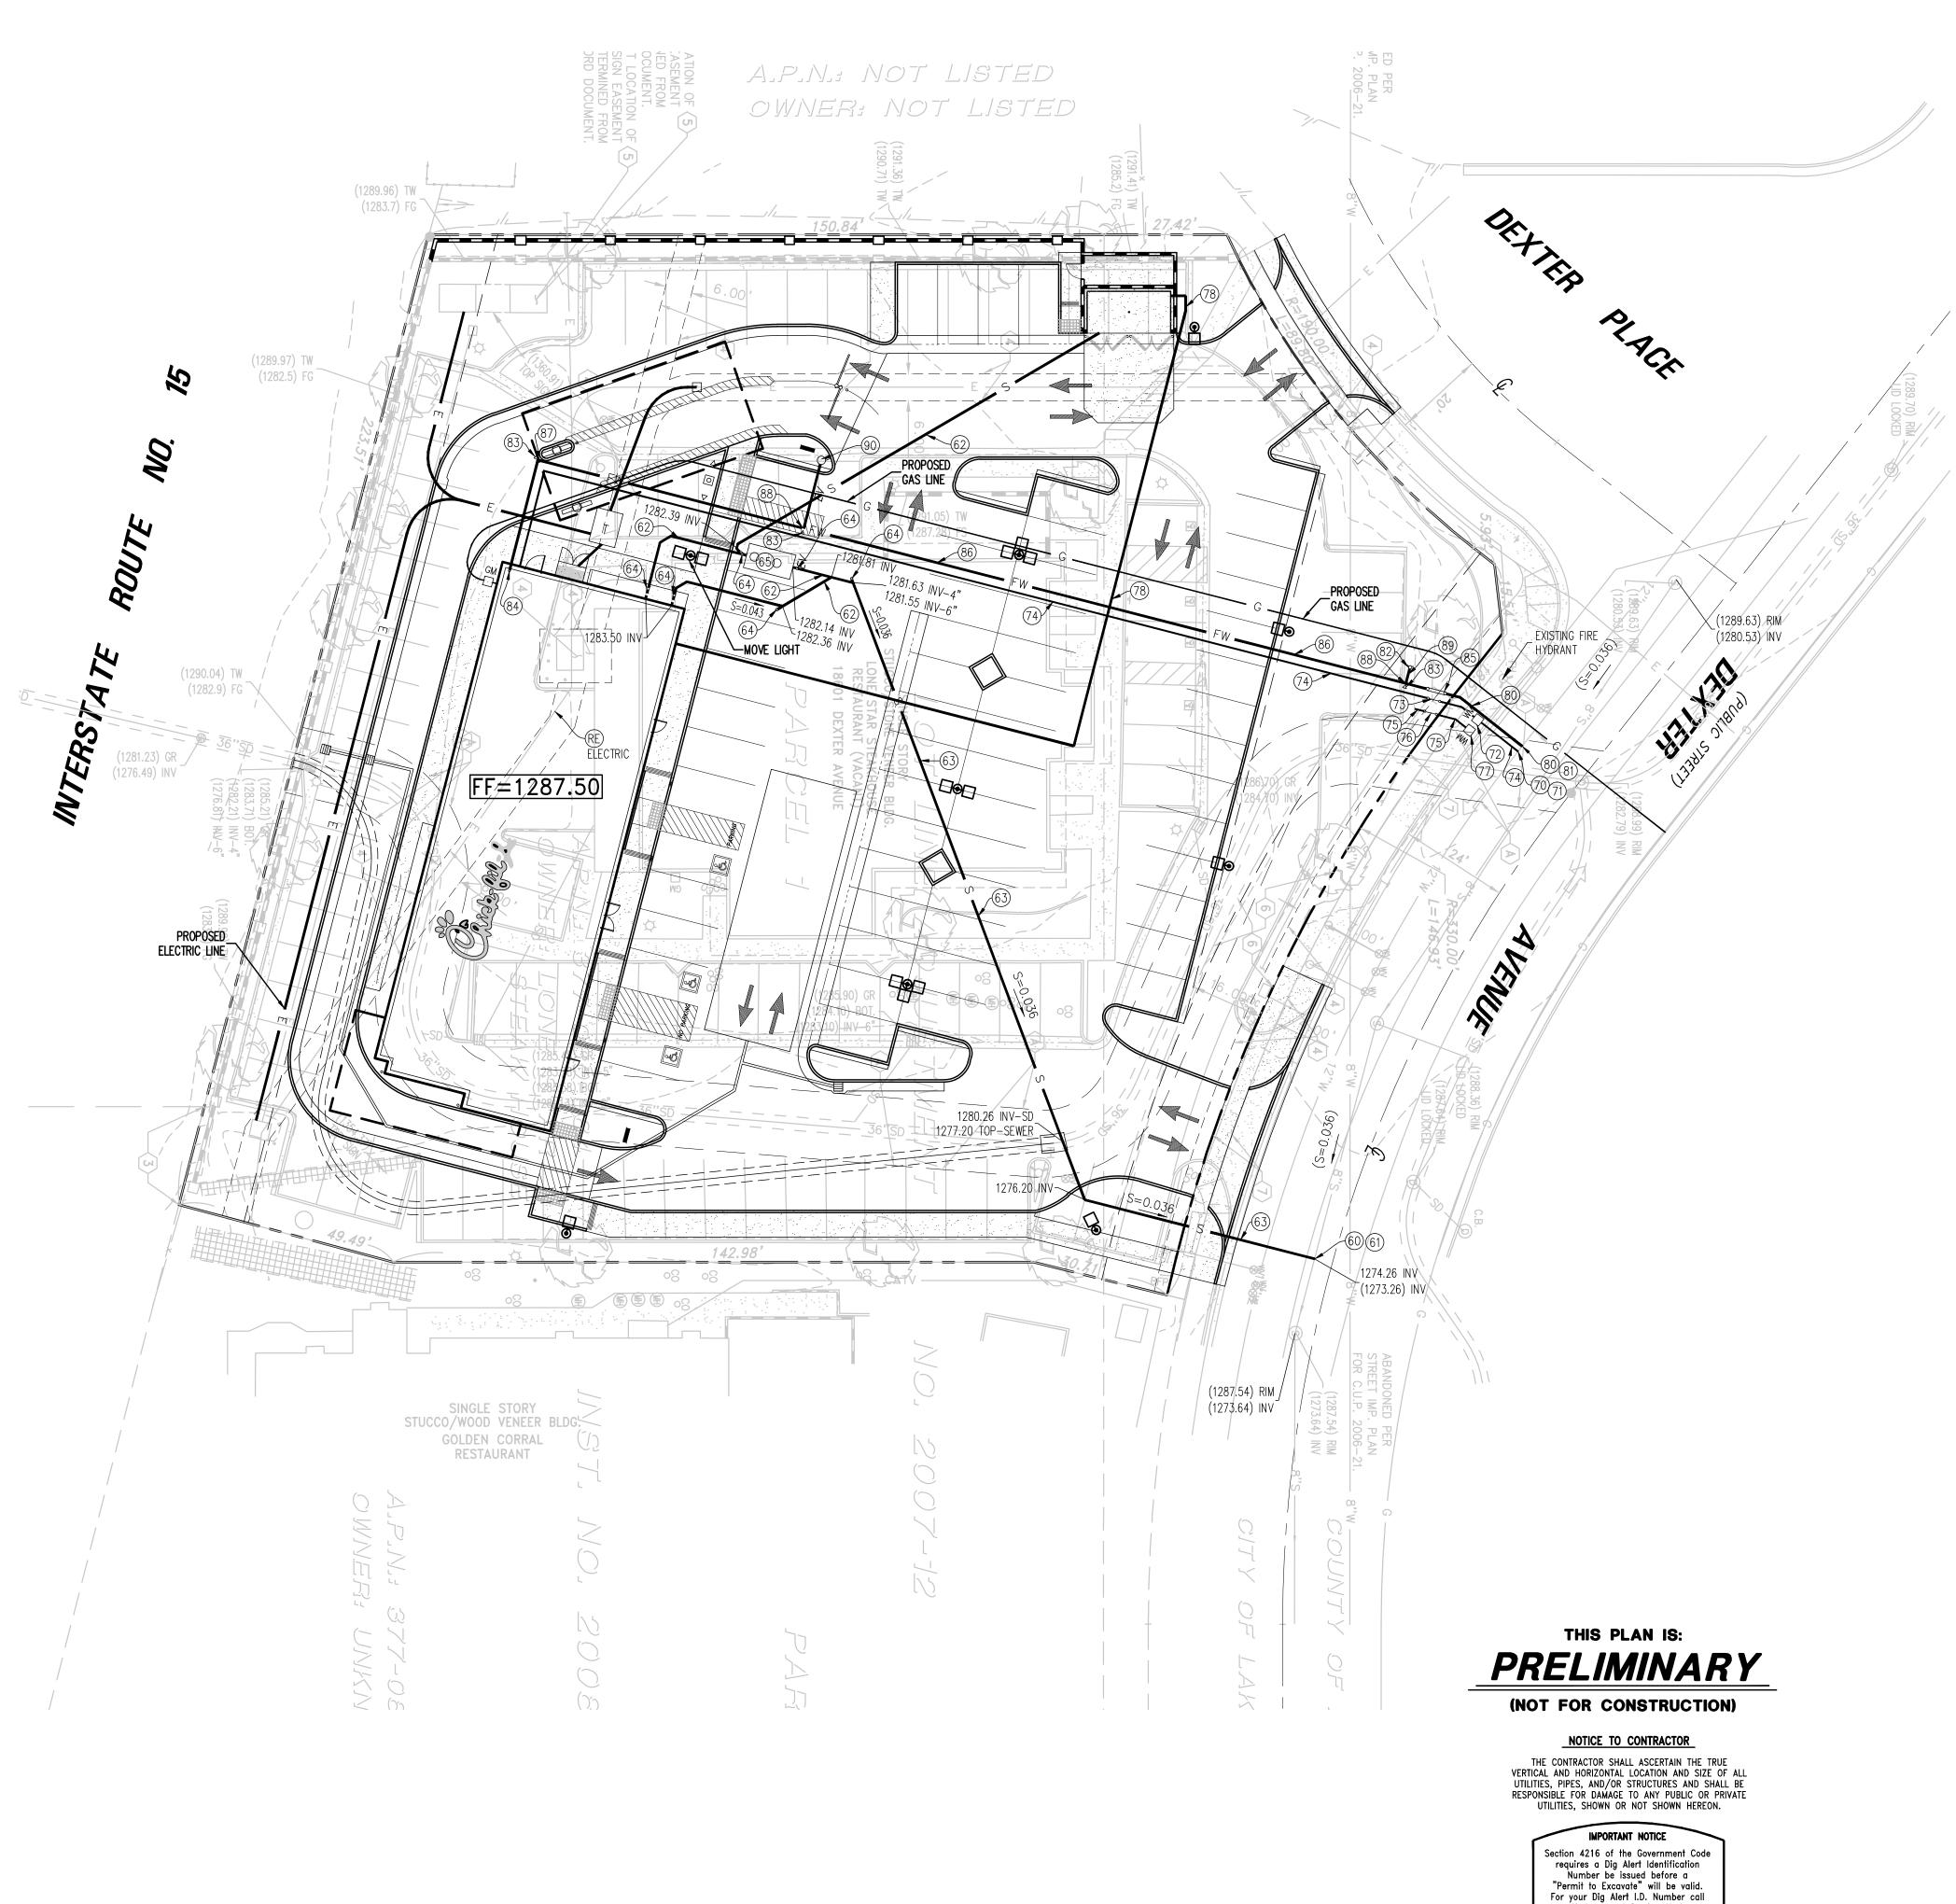



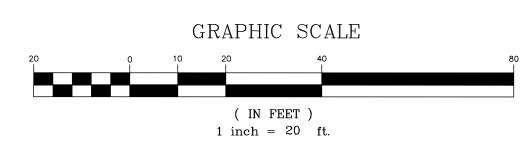

CONSTRUCTION NOTES - SEWER

- POTHOLE AND VERIFY THE EXISTENCE, LOCATION, DEPTH, MATERIAL, SIZE, AND CONDITION OF EXISTING 8" SEWER MAIN. CONTRACTOR TO SCOPE EXISTING SEWER LINE WITH CAMERA AND REPORT FINDINGS TO TRUXAW & ASSOCIATES PRIOR TO CONSTRUCTION.
- (61) CONNECT TO EXISTING SEWER LATERAL PER CPC REQUIREMENTS.
- (62) PLACE 4-INCH SDR-35 PVC SEWER PIPE PER CPC REQUIREMENTS.
- (63) PLACE 6-INCH SDR-35 PVC SEWER PIPE PER CPC REQUIREMENTS.
- INSTALL CLEANOUT PER CITY OF SANTA CLARA STANDARD. SIZE TO MATCH DOWNSTREAM PIPE SIZE.
- (65) GREASE INTERCEPTOR PER PLUMBING PLANS.
- INSTALL DRAIN IN TRASH ENCLOSURE.

WATER (DOMESTIC & IRRIGATION)

- POTHOLE AND VERIFY THE EXISTENCE, LOCATION, DEPTH, MATERIAL, SIZE, AND CONDITION OF EXISTING 12" WATER MAIN. CONTRACTOR TO SCOPE EXISTING SEWER LINE WITH CAMERA AND REPORT FINDINGS TO TRUXAW & ASSOCIATES PRIOR TO CONSTRUCTION.
- (71) CONNECT TO EXISTING WATER MAIN.
- (72) INSTALL 1.5-INCH WATER METER AND CONNECT TO EXISTING WATER LINE. (DOMESTIC)
- (73) INSTALL 2-INCH REDUCED PRESSURE BACKFLOW PREVENTOR. (DOMESTIC)
- 74) PLACE 2-INCH SCH. 80 PVC WATER LINE. (DOMESTIC)
- (75) PLACE 1-INCH SCH. 80 PVC WATER LINE. (IRRIGATION)
- INSTALL 1-INCH REDUCED PRESSURE BACKFLOW PREVENTOR. (IRRIGATION)
- (77) INSTALL 1-INCH WATER METER. (IRRIGATION)
- (78) INSTALL 3/4-INCH SCH. 80 WATER LINE. (TRASH ENCLOSURE)

WATER (FIRE SERVICE)

- POTHOLE AND VERIFY THE EXISTENCE, LOCATION, SIZE, DEPTH, MATERIAL AND CONDITION OF EXISTING 12—INCH WATER MAIN. LATERAL MUST BE AT LEAST 6—INCHES TO BE ADEQUATE FOR USE. REPORT ALL FINDINGS TO TRUXAW & ASSOCIATES PRIOR TO CONSTRUCTION.
- CONNECT TO EXISTING WATER MAIN PER CITY STANDARDS.
- INSTALL FDC PER CITY STANDARDS.
- CONSTRUCT CONCRETE THRUST BLOCK.
- CONNECT TO FIRE RISER.
- INSTALL DOUBLE DETECTOR CHECK PER CITY STANDARDS.
- PLACE 6-INCH C-900 CL-200 PVC WATER LINE. (USE 1-PIECE STAINLESS STEEL RISER WITHIN 5 FEET OF BUILDING FOOTPRINT).
- ** (87) INSTALL 6-INCH 90° DUCTILE IRON ELBOW.
- ** (88) INSTALL 6-INCH X 4-INCH DUCTILE IRON TEE.
- ** (89) PLACE 4-INCH C-900 CL-200 PVC WATER LINE. (USE 1-PIECE STAINLESS STEEL RISER WITHIN 5 FEET OF BUILDING FOOTPRINT).
- ** (90) INSTALL FIRE HYDRANT.
- ** FIRE PROTECTION PIPE LINE AND SPRINKLERS IN THE BUILDING TO BE DESIGNED AND PERMITTED BY SEPARATE PLANS. PRIOR TO CONSTRUCTION OF FIRE WATER SYSTEM SHOWN ON THIS PLAN, CONTRACTOR SHALL VERIFY VIA HYDRAULIC CALCULATIONS ACCEPTABLE TO THE FIRE DEPARTMENT THAT SIZE OF FIRE SERVICE & DETECTOR CHECK ARE OF SUFFICIENT SIZE TO SERVE BUILDING. (SIZE SHOWN FOR PLAN CHECK & BID PURPOSES ONLY).

DRY UTILITIES

PROPOSED ELECTRIC, TELEPHONE, CABLE TV, AND GAS LINES ARE SHOWN HEREON FOR COORDINATION PURPOSES. CONTRACTOR TO VERIFY POINTS OF CONNECTION AND CONSTRUCT PROPOSED SERVICE LINES IN ACCORDANCE WITH SERVICE PLANNING DOCUMENTS PREPARED BY EACH RESPECTIVE UTILITY COMPANY.

GENERAL NOTES

Underground Service Alert

CALL 811

wo working days before you di

DEVELOPER TO MAINTAIN UTILITIES SERVICE AND ACCESS TO SURROUNDING PROPERTIES CONSTRUCTION.






5200 Buffington Rd Atlanta Georgia, 30349-2998

Revisions: Mark Date By

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Mark Date By

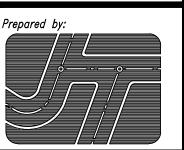

JOSEPH C. TRUXAW & ASSOCIATES, INC.

Civil Engineers and Land Surveyors 265 S. ANITA DRIVE, SUITE 11 ORANGE, CA 92868 (714) 935-0265 (714) 935-0106 (FAX)

STORE

CENTRAL AVENUE & DEXTER AVENUE

LAKE ELSINORE, CALIFORNIA

SHEET TITLE CONCEPTUAL UTILITY

VERSION: ISSUE DATE:

: <u>CFA0610</u> Job No. : <u>#</u>04261 Store . 03–07–18 Drawn By

Checked By: SMH

TITLE REPORT

THIS SURVEY AND EASEMENTS SHOWN HEREON ARE BASED ON INFORMATION CONTAINED IN THE PRELIMINARY TITLE REPORT PREPARED BY:

FIRST AMERICAN TITLE INSURANCE COMPANY
4380 LA JOLLA VILLAGE DRIVE, SUITE 110
SAN DIEGO, CA 92122
(858) 410-2151
COMMITMENT NUMBER: NCS-882366-SD
COMMITMENT DATE: NOVEMBER 27, 2017
TITLE OFFICER: TRIXY BROWN / JANICE TREANOR

LEGAL DESCRIPTION

REAL PROPERTY IN THE CITY OF LAKE ELSINORE, COUNTY OF RIVERSIDE, STATE OF CALIFORNIA, DESCRIBED AS FOLLOWS:

PARCEL 1 AS SHOWN ON NOTICE OF LOT LINE ADJUSTMENT NO. 2007—12, AS EVIDENCED BY DOCUMENT RECORDED ON MARCH 18, 2008 AS INSTRUMENT NO. 2008—000131995, OF OFFICIAL RECORDS, BEING MORE DESCRIBED AS FOLLOWS:

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TOGETHER WITH THAT PORTION OF DEXTER AVENUE ABUTTING SAID LAND AND LYING BETWEEN THE NORTHERLY PROLONGATION OF THE NORTHWESTERLY AND THE SOUTHEASTERLY BOUNDARIES OF SAID LAND AS CONTAINED IN RESOLUTION RECORDED MAY 11, 1990 AS INSTRUMENT NO. 174610 OF OFFICIAL RECORDS.

EXCEPT THEREFROM THAT PORTION AS CONVEYED TO THE STATE OF CALIFORNIA BY DEED RECORDED OCTOBER 10, 1978 AS INSTRUMENT NO. 213000, OFFICIAL RECORDS.

BEGINNING AT THE CENTERLINE INTERSECTION OF DEXTER AVENUE AND THIRD AVENUE (OLD ALIGNMENT) AS SHOWN ON A CALTRANS RIGHT OF WAY MAP NO. 916532, RECORDS OF CALTRANS, DISTRICT NO. 8, SHOWING THIS AREA WITHIN THE CITY OF ELSINORE AREA, COUNTY OF RIVERSIDE, STATE OF CALIFORNIA. THENCE NORTH 46" 13" 18" WEST ALONG THE CENTERLINE OF DEXTER AVENUE A DISTANCE OF 246.44 FEET THENCE SOUTH 43' 46' 11" WEST 30.00 FEET TO THE NORTHEAST CORNER OF SAID PARCEL 3; THENCE NORTH 46' 13' 18" WEST 103.73 FEET ALONG SOUTHERLY RIGHT OF WAY OF DEXTER AVENUE 30 FEET WIDE AS IT NOW EXIST TO A NON-TANGENT CURVE CONCAVE NORTHEASTERLY WITH A RADIUS OF 330.00 FEET, A RADIAL LINE THROUGH SAID POINT BEAR NORTH 43' 46' 42" EAST; THENCE NORTHWESTERLY ALONG SAID CURVE THROUGH A CENTRAL ANGLE OF 12' 43' 37". AN ARC DISTANCE OF 73.08 FEET TO THE TRUE POINT OF BEGINNING THENCE SOUTH 57° 36' 58" WEST 34.72 FEET; THENCE SOUTH 43° 45' 11" WEST 142.98 FEET; THENCE SOUTH 58° 46' 55" WEST 49.49 FEET TO THE SOUTH WESTERLY LINE OF SAID PARCEL 3 THENCE NORTH 31° 49' 10" WEST 223.51 FEET; THENCE NORTH 43° 45' 11" EAST 150.84 FEET; THENCE NORTH 43' 43' 52" EAST 27.42 FEET TO A POINT ON THE SOUTHERLY RIGHT OF WAY OF DEXTER PLACE 30.00 FEET WIDE AS IT NOW EXIST SAID POINT ON A NON-TANGENT CURVE, CONCAVE SOUTHEASTERLY, WITH A RADIUS OF 190.00 FEET, A RADIAL LINE THROUGH SAID POINT BEAR NORTH 19" 03' 05" EAST; THENCE NORTHEASTERLY ALONG SAID CURVE THROUGH A CENTRAL ANGLE OF 27° 04' 33", AN ARC DISTANCE OF 89.79 FEET; THENCE NORTH 81° 58' 32" EAST 5.93 FEET; THENCE NORTH 53' 01' 28" WEST 21.21 FEET TO THE WESTERLY RIGHT OF WAY OF DEXTER AVE THENCE SOUTH 08° 01' 28" EAST 14.60 FEET TO A NON TANGENT CURVE, CONCAVE SOUTHEASTERLY, WITH A RADIUS OF 330.00 FEET, A RADIAL LINE THROUGH SAID POINT BEAR NORTH 81° 58' 32" EAST THENCE SOUTHERLY ALONG SAID CURVE THROUGH A CENTRAL ANGLE OF 25° 30' 13", AN ARC DISTANCE OF 146.92 FEET TO THE TRUE POINT OF BEGINNING.

APN: 377-080-084-7

EASEMENT NOTES

REFER TO TITLE REPORT FOR ADDITIONAL INFORMATION AND DETAILS:

- 1-2 ITEMS THAT DEAL WITH TAXES.
- ABUTTER'S RIGHTS OF INGRESS AND EGRESS TO OR FROM FREEWAY HAVE BEEN RELINQUISHED IN THE DOCUMENT RECORDED OCTOBER 10, 1978 AS
- INSTRUMENT NO. 213000 OF OFFICIAL RECORDS.

 NOTE: SAID DOCUMENT ACCOUNTS FOR A PORTION OF RELINQUISHED ACCESS RIGHTS AS SHOWN ON THE SURVEY. RELINQUISHED ACCESS RIGHTS ALONG THE WESTERLY PARCEL 1 (R1) LINE ARE SHOWN PER CALTRANS MAP (R3).
- AN EASEMENT FOR PUBLIC UTILITIES AND INCIDENTAL PURPOSES, RECORDED APRIL 16, 2008 AS INSTRUMENT NO. 2008—0189715 OF OFFICIAL RECORDS. IN FAVOR OF:

 SOUTHERN CALIFORNIA EDISON COMPANY, A CORPORATION, ITS SUCCESSORS AND ASSIGNS
- AFFECTS: AS DESCRIBED THEREIN

 NOTE: THE LAST COURSE OF STRIP NO. 4 IN SAID DOCUMENT APPEARS TO BE IN ERROR. THE COURSE OF NORTH 43°43′52" EAST IS PLOTTED HEREON INSTEAD OF NORTH 43°43′52" WEST AS STATED IN THE DOCUMENT, IN ORDER TO ALIGN WITH THE GIVEN DISTANCE AND CONNECTED TO STRIP NO. 5. PER THE DOCUMENT. ALSO AN EXISTING ELECTRICAL VAULT IS LOCATED OUTSIDE OF STRIP NO. 5 ALONG DEXTER PLACE.
- THE TERMS, PROVISIONS AND EASEMENT(S) CONTAINED IN THE DOCUMENT ENTITLED "FREEWAY SIGN EASEMENT AGREEMENT" RECORDED APRIL 18, 2008 AS INSTRUMENT NO. 2008-0195591 OF OFFICIAL RECORDS.
- NOTE: THE EXACT LOCATION OF THE FREEWAY SIGN EASEMENT CANNOT BE DETERMINED FROM THE RECORD DOCUMENT. THE SHOPPING CENTER FREEWAY PYLON SIGN IS LOCATED AT WESTERLY CORNER AS SHOWN ON THE SURVEY.
- AN EASEMENT FOR PUBLIC STREET AND INCIDENTAL PURPOSES, RECORDED OCTOBER 09, 2008 AS INSTRUMENT NO. 2008-0546334 OF OFFICIAL RECORDS.
 IN FAVOR OF: CITY OF LAKE ELSINORE, A MUNICIPAL CORPORATION,

ITS SUCCESSORS AND ASSIGNS

AN OFFER OF DEDICATION FOR RIGHT OF WAY AND INCIDENTAL PURPOSES, RECORDED OCTOBER 09, 2008 AS INSTRUMENT NO. 2008-0546335 OF OFFICIAL RECORDS.

AS DESCRIBED THEREIN

- CITY OF LAKE ELSINORE, A MUNICIPAL CORPORATION, ITS SUCCESSORS AND ASSIGNS
- A DEED OF TRUST TO SECURE AN ORIGINAL INDEBTEDNESS OF \$1,280,000.00 RECORDED JUNE 26, 2014 AS INSTRUMENT NO. 2014—234566 OF OFFICIAL RECORDS.

DATED: JUNE 12, 2014
TRUSTOR: FU-TSAN CHEN AND REYNA CHEN, HUSBAND AND WIFE, AS

JOINT TENANTS

TRUSTEE: EAST WEST INVESTMENT INC., A CALIFORNIA CORPORATION

BENEFICIARY: EAST WEST BANK

A DOCUMENT ENTITLED "ASSIGNMENT OF RENTS" RECORDED JUNE 26, 2014 AS INSTRUMENT NO. 2014—234567 OF OFFICIAL RECORDS, AS ADDITIONAL SECURITY FOR THE PAYMENT OF THE INDEBTEDNESS SECURED BY THE DEED OF TRUST

NOTE: SAID DOCUMENTS ARE NON-SURVEY ITEMS AND NOT PLOTTED HEREON.

- ANY CLAIM THAT THE TITLE IS SUBJECT TO A TRUST OR LIEN CREATED UNDER THE PERISHABLE AGRICULTURAL COMMODITIES ACT, 1930 (7 U.S.C. §\$499A, ET SEQ.) OR THE PACKERS AND STOCKYARDS ACT (7 U.S.C. §\$181 ET SEQ.) OR UNDER SIMILAR STATE LAWS.
- AN ALTA/NSPS SURVEY OF RECENT DATE WHICH COMPLIES WITH THE CURRENT MINIMUM STANDARD DETAIL REQUIREMENTS FOR ALTA/NSPS LAND TITLE SURVEYS.
- ANY FACTS, RIGHTS, INTERESTS OR CLAIMS WHICH WOULD BE DISCLOSED BY A CORRECT ALTA/NSPS SURVEY.
- 12 RIGHTS OF PARTIES IN POSSESSION.

ITEM(S) BELOW IS NOT LISTED IN THE SUBJECT TITLE REPORT LISTED HEREON:

(A) = PROPOSED 15 FOOT PUBLIC STORM DRAIN EASEMENT, SHOWN PER CITY OF LAKE ELSINORE GRADING PLAN FOR LONESTAR STEAK HOUSE DATED NOV. 2007.

RECORD DATA

(R1) = RECORD DATA PER LOT LINE ADJUSTMENT NO. 2007-12, RECORDED MARCH 18, 2008 AS INSTRUMENT NO. 2008-0131995, OFFICIAL RECORDS

(R2) = PARCEL MAP 8914, BOOK 34, PAGE 84.

(R3) = CALTRANS R/W MAP 916532, RECORDS OF CALTRANS DISTRICT NO. 8

(DE) = MISCELLANEOUS RECORD DEED LEGAL DESCRIPTION.

SITE AREA

SUBJECT SITE CONTAINS APPROXIMATELY: GROSS TO P/L = 52,717 SQUARE FEET OR 1.210 ACRES NET TO R/W = 49,872 SQUARE FEET OR 1.145 ACRES

PARKING COUNT

88 STRIPED PARKING STALLS LIE WITHIN THE SUBJECT SITE PROPERTY LINES (INCLUDES 4 HANDICAP STALLS)

FLOOD ZONE

BENCHMARK

CITY OF LAKE ELSINORE BENCHMARK NO. B-95-55 ELEVATION = 1270.68 FEET (DEC. 1995)

CHISELED SQUARE ON TOP OF HEADWALL. FROM THE APPROXIMATE INTERSECTION OF COLLIER AVENUE AND THIRD STREET 45 FEET NORTHWESTERLY ALONG COLLIER AND 45 FEET SOUTHWESTERLY TO THE SOUTHERLY END OF HEAD WALL AT CHANNEL.

BASIS OF BEARINGS

THE BEARING NORTH 08° 01' 28" WEST FOR THE CENTERLINE OF DEXTER AVENUE AS SHOWN ON LOT LINE ADJUSTMENT NO. 2007-12 RECORDED MARCH 18, 2008 AS INSTRUMENT NO. 2008-0131995 OF MAPS, RECORDS OF THE COUNTY OF RIVERSIDE, STATE OF CALIFORNIA, WAS USED AS THE BASIS OF BEARINGS FOR THIS SURVEY.

SITE PLANNING DATA

SITE INVESTIGATION REPORT WAS NOT AVAILABLE AT THE TIME OF THIS SURVEY, INFORMATION BELOW IS PRELIMINARY PER 4G DEVELOPMENT RESEARCH.

NG: C-2 (GENERAL COMMERCIAL), REQUIRES C.U.P.

SETBACKS: (LANDSCAPE AND BUILDING)

NORTH = 0 FT.; SOUTH = 0 FT.; EAST = AVERAGE 20 FT. (MINIMUM 15 FT.) WEST = AVERAGE 20 FT. (MINIMUM 15 FT.)

MAXIMUM BUILDING HEIGHT: 45 FT.

SURVEYOR'S NOTES

VICINITY MAP

NOT TO SCALE

1. IT IS NOT WITHIN THE PURVIEW OF THIS SURVEYOR TO MAKE DETERMINATIONS OF OWNERSHIP. AS TO "ENCROACHMENTS" SPECIFICALLY, NO INFERENCE TO SUCH DETERMINATION IS INTENDED OR IMPLIED.

AVENUE

- 2. LOCATIONS OF UNDERGROUND UTILITIES / STRUCTURES MAY VARY FROM LOCATIONS SHOWN HEREON. ADDITIONAL BURIED UTILITIES / STRUCTURES MAY EXIST. NO EXCAVATIONS WERE MADE DURING THE PROGRESS OF THIS SURVEY TO LOCATE BURIED UTILITIES / STRUCTURES. THE LOCATIONS OF UNDERGROUND FEATURES SHOWN HEREON ARE PLOTTED FROM AVAILABLE RECORD INFORMATION AND VISIBLE SURFACE INDICATIONS. BEFORE ANY EXCAVATIONS ARE PERFORMED, UTILITY PURVEYORS SHOULD BE CONTACTED FOR VERIFICATION OF UTILITY TYPE AND FIELD LOCATIONS.
- 3. VEHICULAR ACCESS TO THE "SUBJECT SITE" IS CURRENTLY FROM A DRIVE ENTRANCE ALONG DEXTER AVENUE.
- 4. ALL MATTERS SHOWN ON RECORDED PLATS LISTED IN RECORD DATA HEREON THAT ARE PERTINENT TO THE SURVEY OF THE SUBJECT SITE ARE SHOWN ON THIS ALTA SURVEY HEREON.
- 5. AT THE TIME OF SURVEY NO EVIDENCE OF RECENT EARTH MOVING WORK, BUILDING CONSTRUCTION OR ADDITIONS WERE OBSERVED ON THE SUBJECT SITE.
- 6. NO RECENT CHANGES IN STREET RIGHTS-OF-WAY OR STREET CONSTRUCTION OR REPAIRS WERE OBSERVED AT THE TIME OF SURVEY.
 ON-SITE PARKING AND DRIVE LANE LIE WITHIN THE DEXTER AVENUE RIGHT-OF-WAY SHOWN AT 50 FEET OFFSET FROM THE CENTERLINE.
- 7. NO VISIBLE EVIDENCE WAS OBSERVED THAT THE SITE IS BEING USED AS A SOLID WASTE DUMP, SUMP OR SANITARY LANDFILL AT THE TIME OF SURVEY.

SURVEY CERTIFICATION

TO: CHICK-FIL-A, INC. AND FIRST AMERICAN TITLE INSURANCE COMPANY,

THIS IS TO CERTIFY THAT THIS MAP OR PLAT AND THE SURVEY ON WHICH IT IS BASED WERE MADE IN ACCORDANCE WITH THE 2016 MINIMUM STANDARD DETAIL REQUIREMENTS FOR ALTA/NSPS LAND TITLE SURVEYS, JOINTLY ESTABLISHED AND ADOPTED BY ALTA AND NSPS, AND INCLUDES ITEMS 2, 3, 4, 5, 6(a), 7(a)(b1), 8, 9, 11, 13, 16 & 17 OF "TABLE A" THEREOF.
THE FIELD WORK WAS COMPLETED ON DECEMBER 12, 2017.

THIS CERTIFICATION IS SUBMITTED PURSUANT TO SECTION 8770.6 OF THE PROFESSIONAL LAND SURVEYORS ACT, BUSINESS AND PROFESSIONS CODE, STATE OF CALIFORNIA.

STEPHEN M. HAGER DATE
REGISTERED LAND SURVEYOR NO. 6161



UTILITY PROVIDERS

ROADWAY......CITY OF LAKE ELSINORE, 130 S. MAIN STREET, LAKE ELSINORE 92530, RITA THOMPSON (951) 674-3124 x308 ROADWAY......COUNTY OF RIVERSIDE TRANSPORTATION DEPT., 4080 LEMON ST. 3RD FLOOR, RIVERSIDE 92501, (951) 955-6880

+ AGENCY RECORD INFORMATION NOT AVAILABLE AT THE TIME OF THIS SURVEY.



5200 Buffington Rd. Atlanta Georgia,

30349-2998 Revisions:

Mark Date By

Mark Date By

Mark Date By

Seal

Prepared by:

JOSEPH C. TRUXAW & ASSOCIATES, INC.

Civil Engineers and Land Surveyors 265 S. ANITA DRIVE, SUITE 11: ORANGE, CA 92868 (714) 935-0265 (714) 935-0106 (FAX)

STORE

CENTRAL AVENUE

& DEXTER AVENUE

LAKE ELSINORE, CALIFORNIA

SHEET TITLE
ALTA/NSPS LAND
TITLE SURVEY

VERSION: ISSUE DATE:

Job No. : <u>CFA06108</u>

Store : <u>#04261</u>


Date : <u>01-04-18</u>

Drawn By : <u>SDS</u>

Checked By: <u>SMH</u>

Sheet

of 3

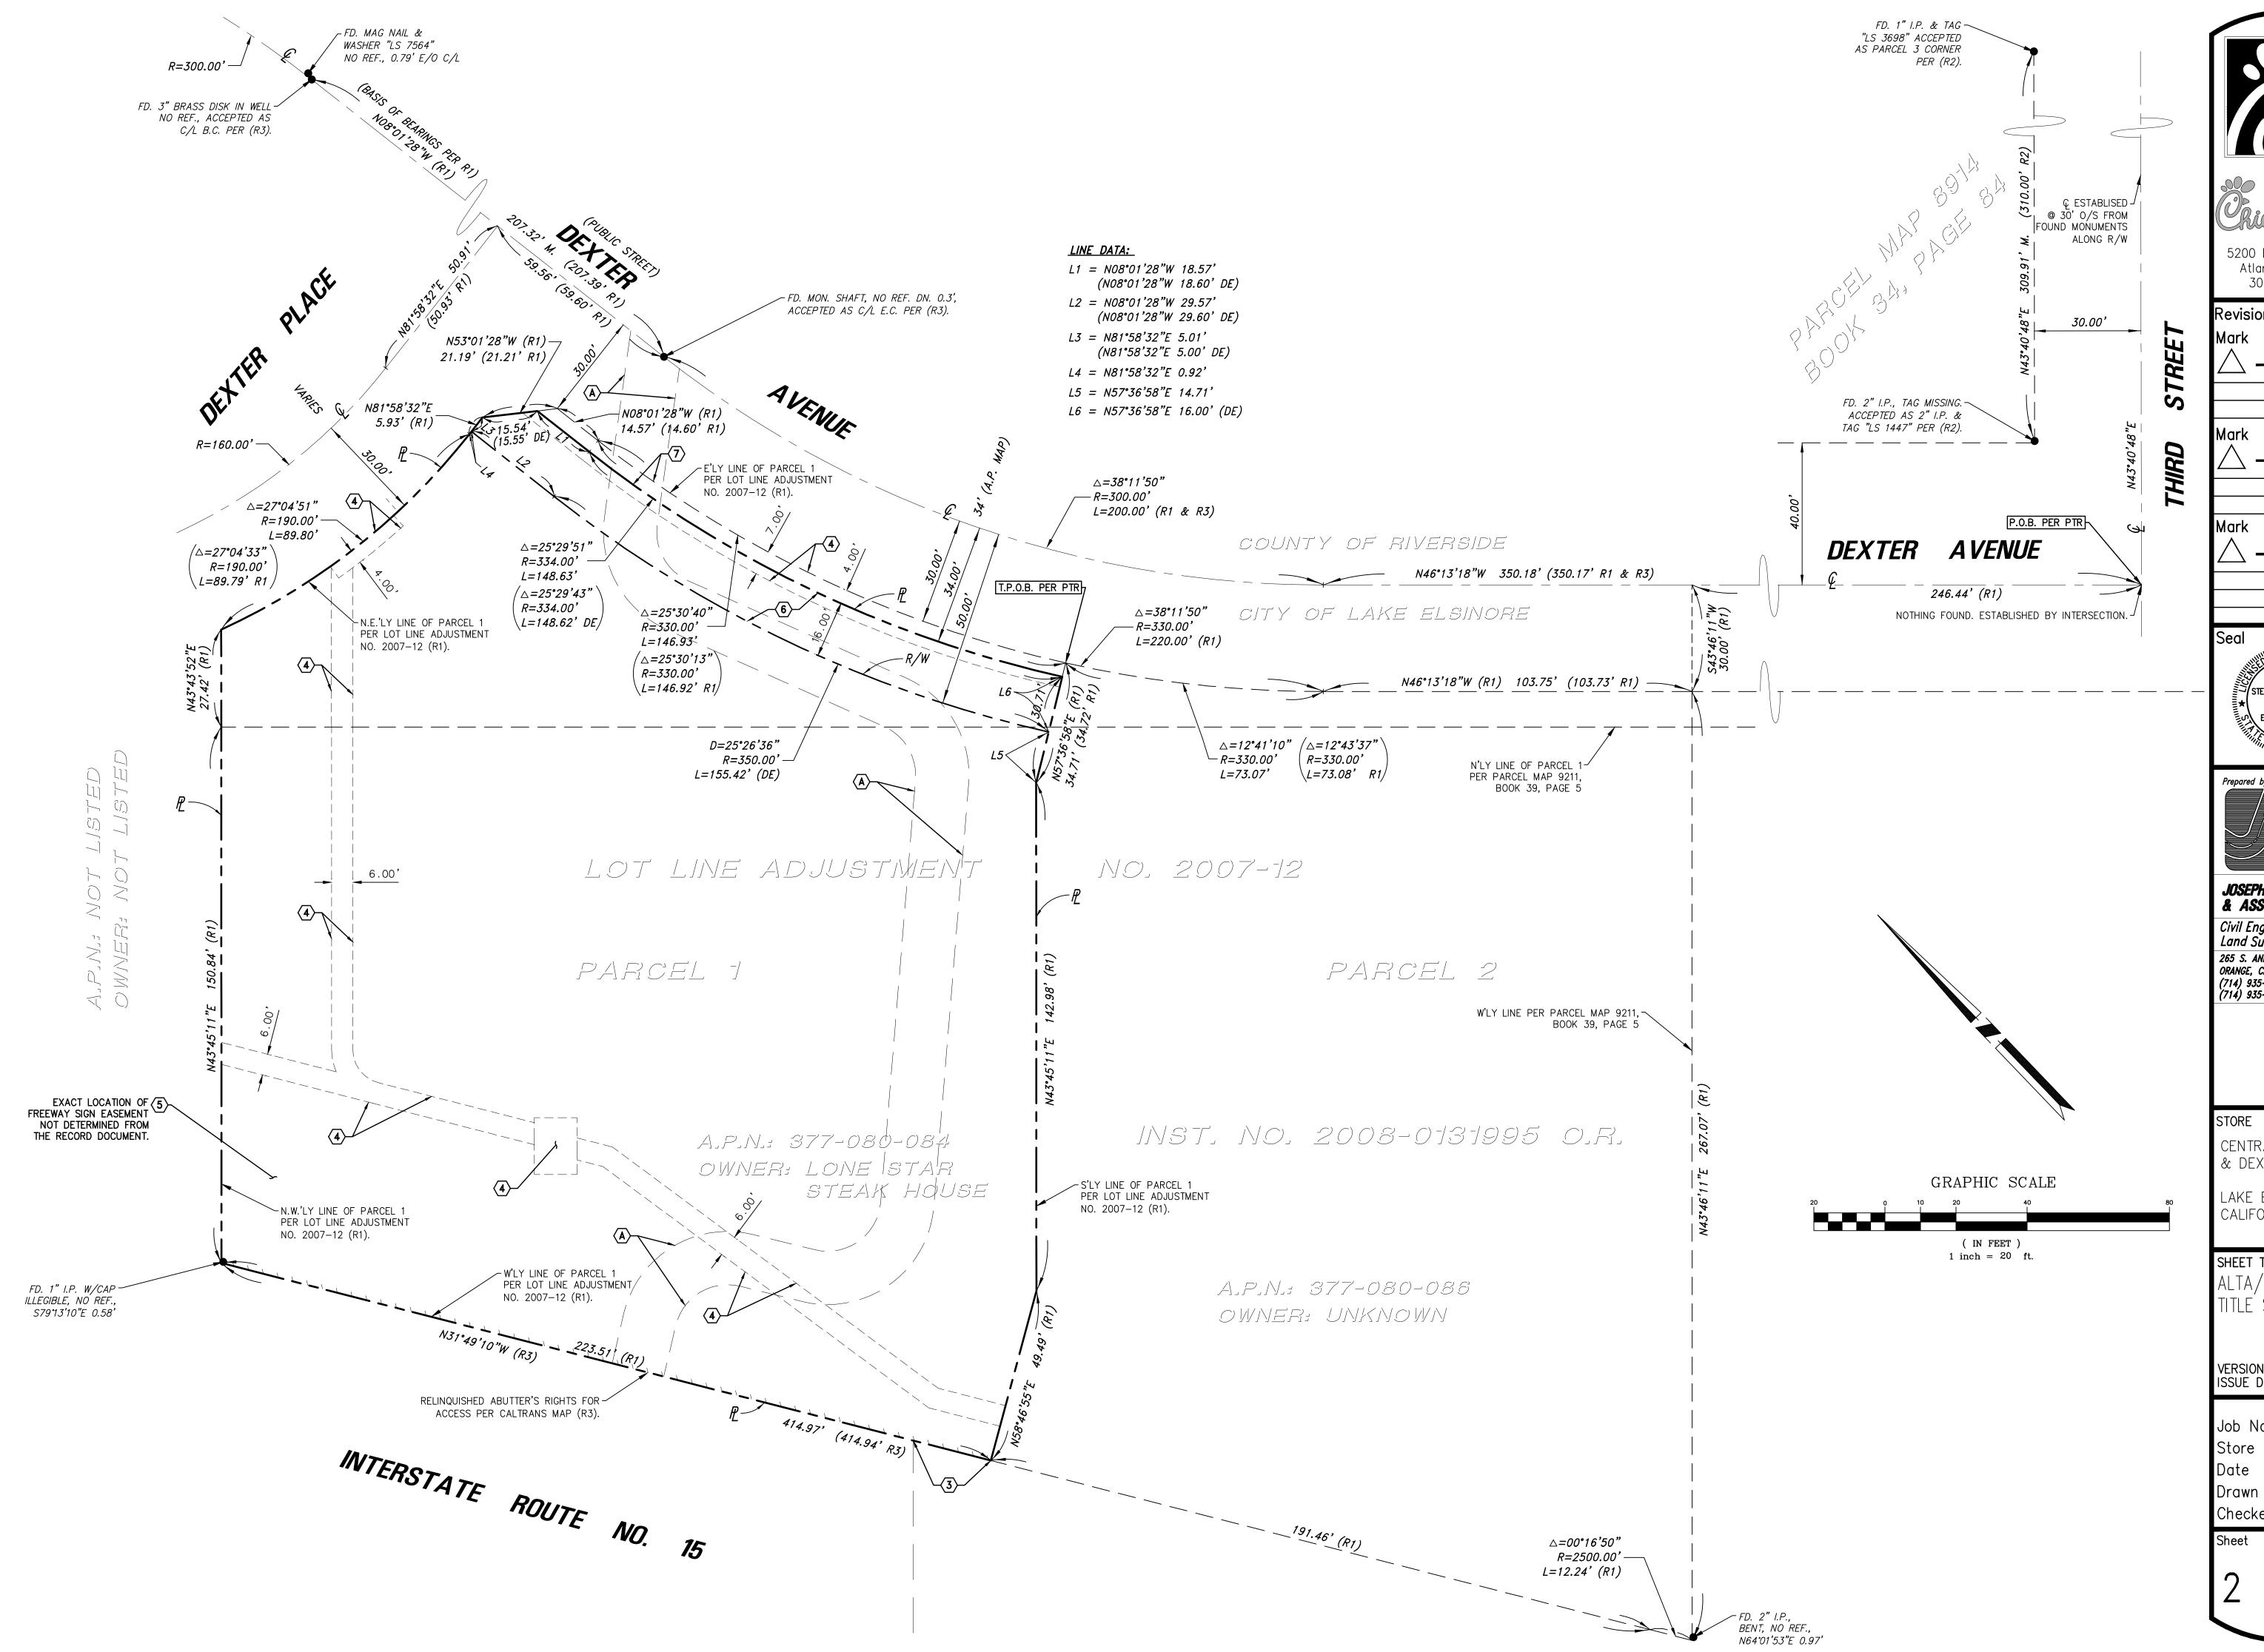






5200 Buffington Rd Atlanta Georgia, 30349-2998

Revisions: Mark Date By

Mark Date By

Mark Date By

STEPHEN M. HAGER

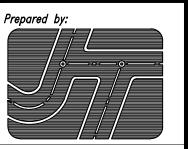

Joseph C. Truxaw & Associates, inc.

Civil Engineers and Land Surveyors 265 S. ANITA DRIVE, SUITE 111 ORANGE, CA 92868 (714) 935-0265 (714) 935-0106 (FAX)

CENTRAL AVENUE & DEXTER AVENUE

LAKE ELSINORE, CALIFORNIA


SHEET TITLE ALTA/NSPS LANI TITLE SURVEY

VERSION: ISSUE DATE:


: <u>CFA0610</u> Job No. : <u>#</u>04261 : 01-04-18 Drawn By : SDS

Checked By: SMH


REFER TO SHEET 2 FOR MONUMENTS AND BOUNDARY DETAILS

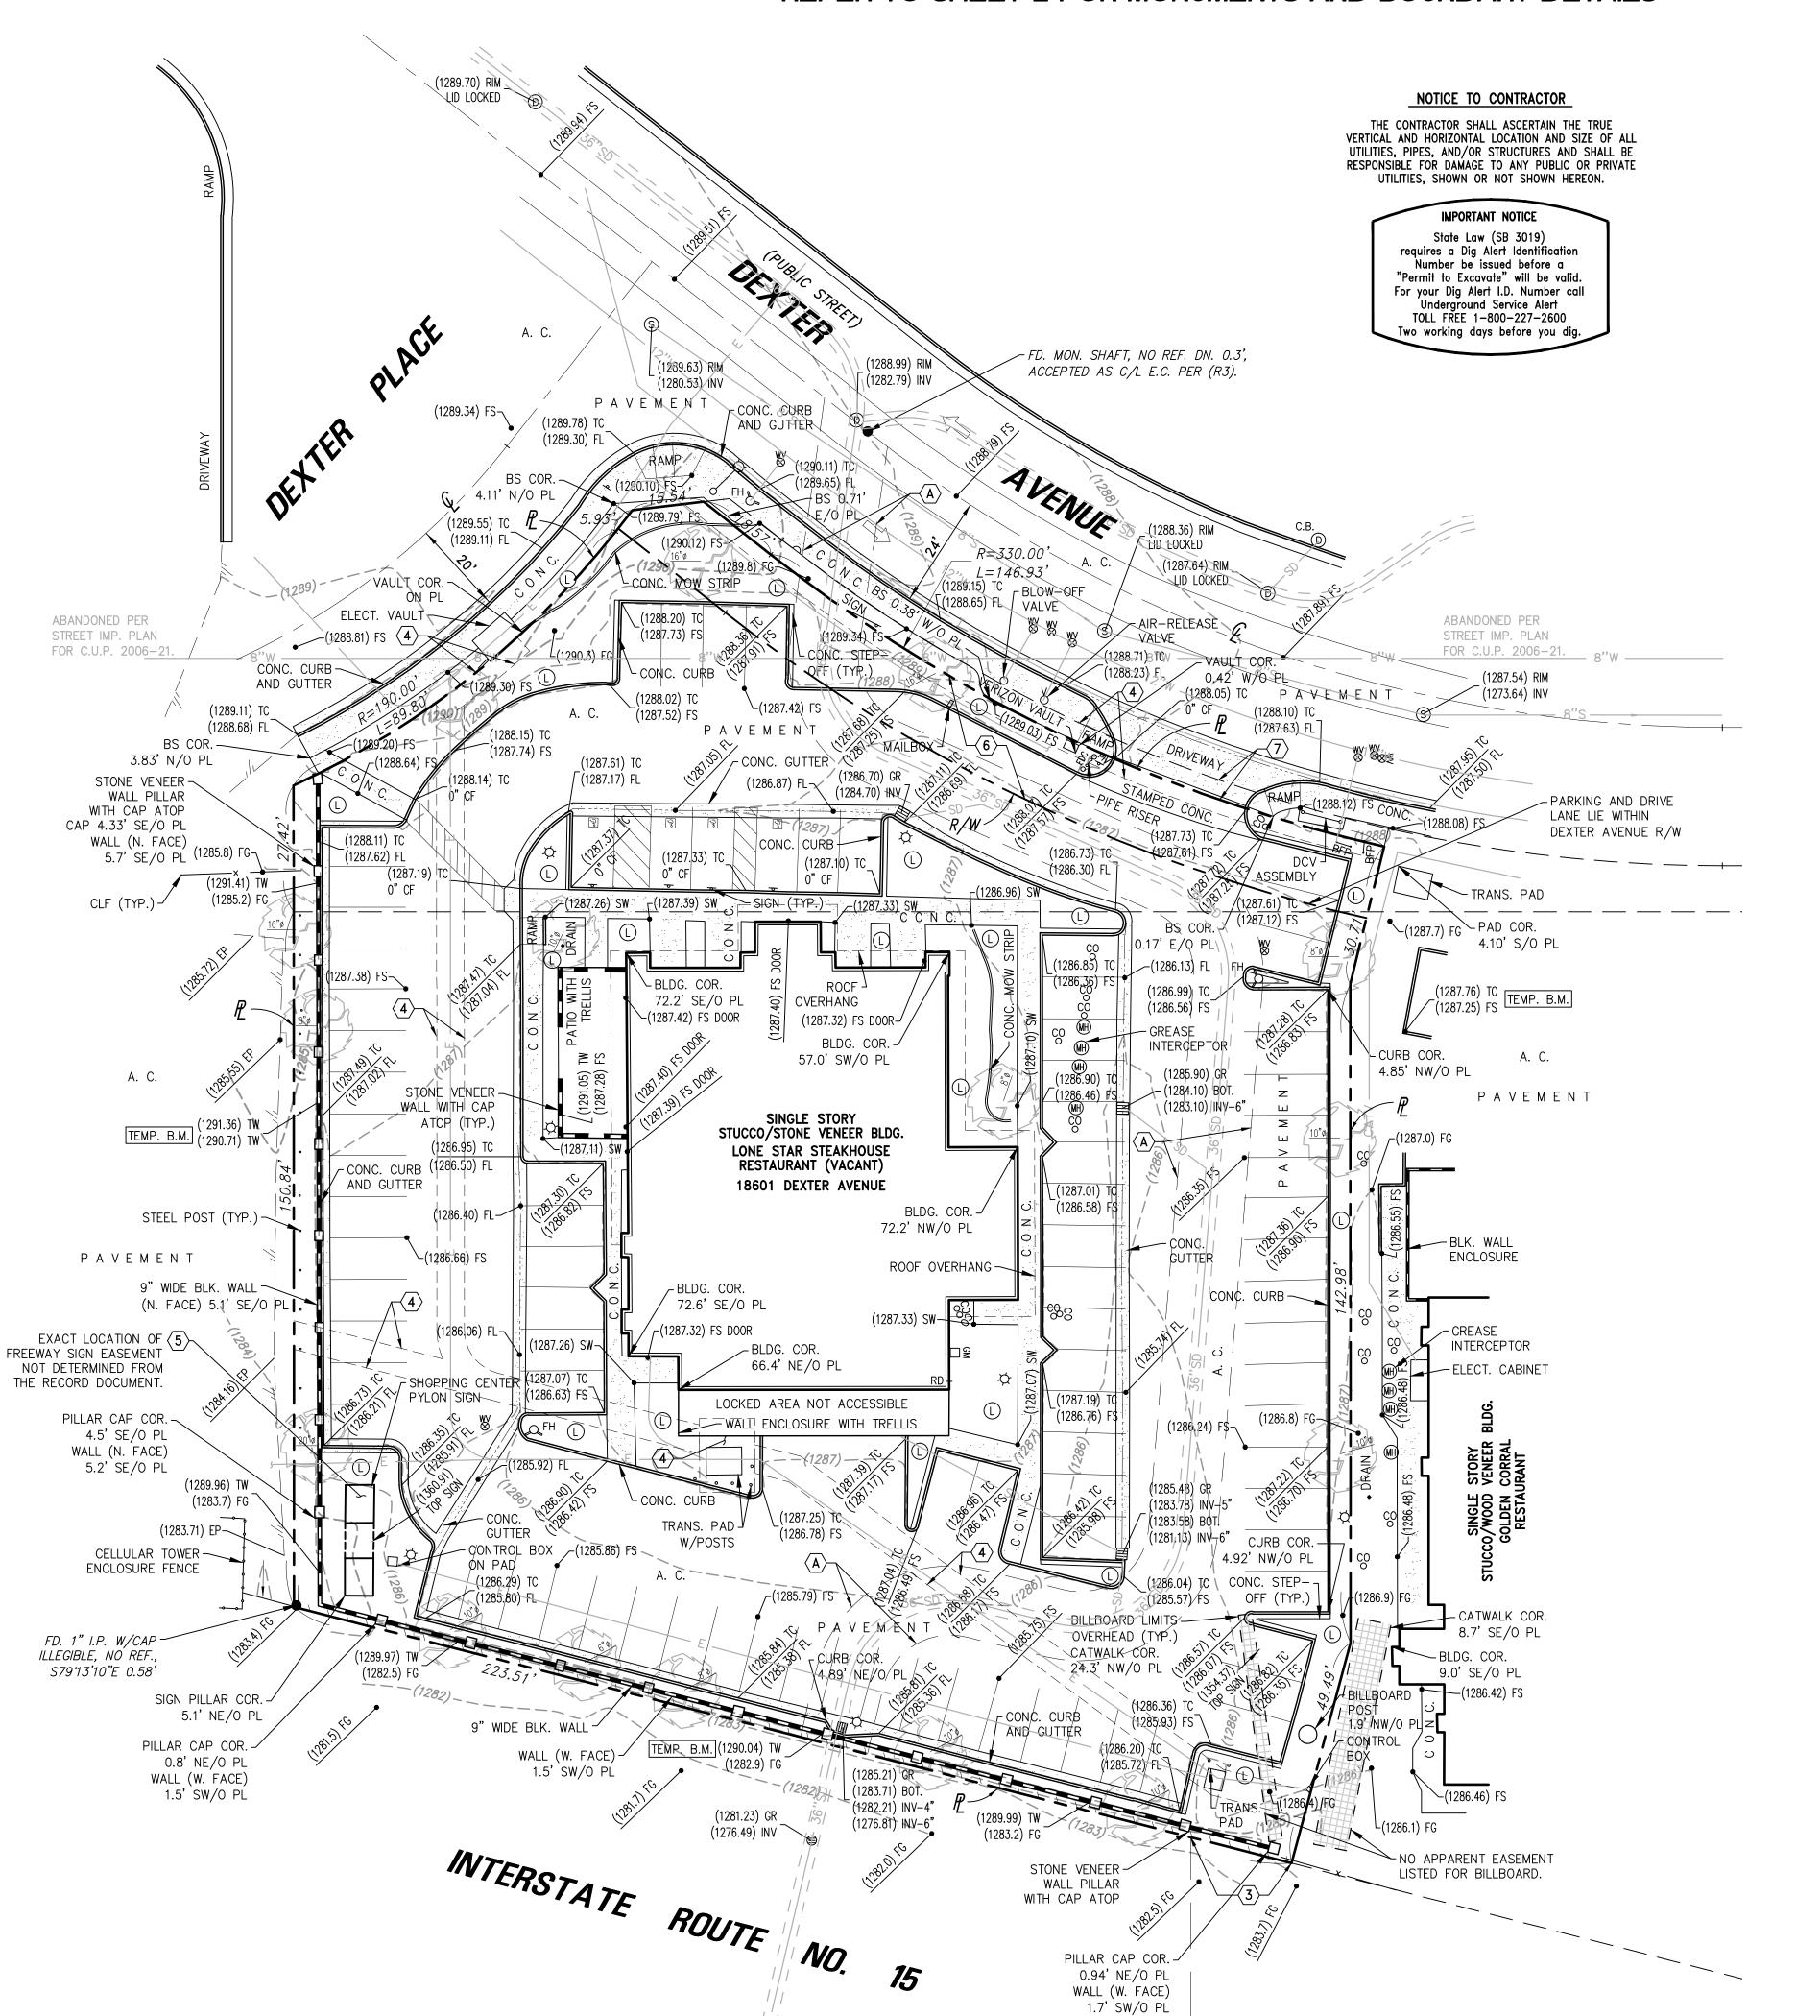



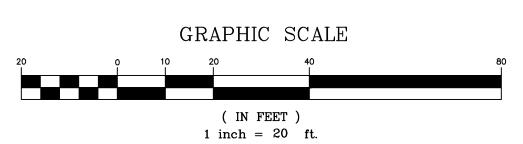

LEGEND	TDW TOD OF DETAILING WALL	SYMBOLS
AC = ASPHALT CONCRETE BFP = BACKFLOW PREVENTOR	TRW = TOP OF RETAINING WALL	A FIRE HYDRANT
BLK = CONCRETE BLOCK	TW = TOP OF WALL UG = UNDERGROUND	o——⇔ STREET LIGHT
BS = BACK OF SIDEWALK	UNK = UNKNOWN	
CB = CATCH BASIN	UP = UTILITY POLE	TRAFFIC CICNAL ADM & DOL
CF = CURB FACE	W = WASHER	*
CL = CENTERLINE	WDF = WOOD FENCE	otrive LIGHT STANDARD
CLF = CHAIN LINK FENCE CO = CLEANOUT	WM = WATER METER	—O— UTILITY POLE
DCV = DETECTOR CHECK VALVE	WV = WATER VALVE	← GUY WIRE & ANCHOR
DS = ROOF DOWNSPOUT	N. = NORTH	WM WATER METER
EG = EDGE OF GUTTER	S. = SOUTH	₩ WATER METER
EP = EDGE OF PAVEMENT	$E. = \; EAST$	GM GAS METER
FD = FOUND	W. = WEST	WV WATER VALVE
FDC = FIRE DEPT. CONNECTION	N'LY = NORTHERLY	
FF = FINISHED FLOOR	S'LY = SOUTHERLY	△ GAS VALVE
	E'LY = EASTERLY W'LY = WESTERLY	PB PULL BOX
	N/O = NORTH OF	GRATE INLET
FS = FINISHED SURFACE	S/O = SOUTH OF	d SIGN
GB = GRADE BREAK	E/O = EAST OF	
GM = GAS METER	W/O = WEST OF	VENT
GR = TOP OF GRATE	\mathbb{P} = PROPERTY LINE	S SEWER MANHOLE
GV = GAS VALVE	$\mathbb{Q}_{\perp} = CENTERLINE$	D STORM DRAIN MANHOLE
HP = HIGH POINT	R/W = RIGHT OF WAY	TELEPHONE MANHOLE
HT = HEIGHT	\triangle = DELTA	_
CV = IRRIGATION CONTROL VALVE	R = RADIUS	\circ
P = IRON PIPE _S = LIGHT STANDARD	L = LENGTH T = TANGENT	CO SEWER CLEANOUT
_&T = LEAD & TAG	M = MEASURED DATA	MONITORING WELL
MH = MANHOLE	C = CALCULATED DATA	HANDICAP PARKING STALL
	(RAD)= RADIAL BEARING	LANDSCAPED AREA
N&T = NAIL & TAG	PRO = PROPORTIONATE MEASUREMENT	P PROTECT IN PLACE
DHW = OVERHEAD WIRE	(210.00' R) = RECORD DATA	R REMOVE AND DISPOSE OFF
PB = PULL BOX	$210.00^{\circ} \text{ M.} = \text{MEASURED DATA}$	=
PCC = CONCRETE	210.00' PRO. = PRORATED DATA	9
PIV = POST INDICATOR VALVE	210.00' C. = CALCULATED DATA	(3) PLOTABLE EASEMENT ITEM No. PER TITLE REPORT
PL = PROPERTY LINE	(427.00) TC = EXISTING ELEVATION	NO. I EN TITLE REPORT
RD = ROOF DRAIN RWH = REDWOOD HEADER	427.00 TC = DESIGN ELEVATION	—— (427.0) —— EXIST. CONTO
SCB = SIGNAL CONTROL BOX		DECION CONT
SMH = SEWER MANHOLE	— E — = ELECTRICAL LINE	427.0 DESIGN CONTO
SPK = SPIKE	———— G ———— = GAS LINE	
SW = SIDEWALK	\longrightarrow GB \longrightarrow GB \longrightarrow = GRADE BREAK LINE	PALM TREE
TC = TOP OF CURB	R $$ R $$ = RIDGE LINE	A THE
TE = TRASH ENCLOSURE	——————————————————————————————————————	
TP = TELEPHONE POLE	SD = STORM DRAIN LINE	
TRAN = TRANSITION	— T — = TELEPHONE LINE	
TRANS= TRANSFORMER	W = WATER LINE	TREE, SPECIES VAI

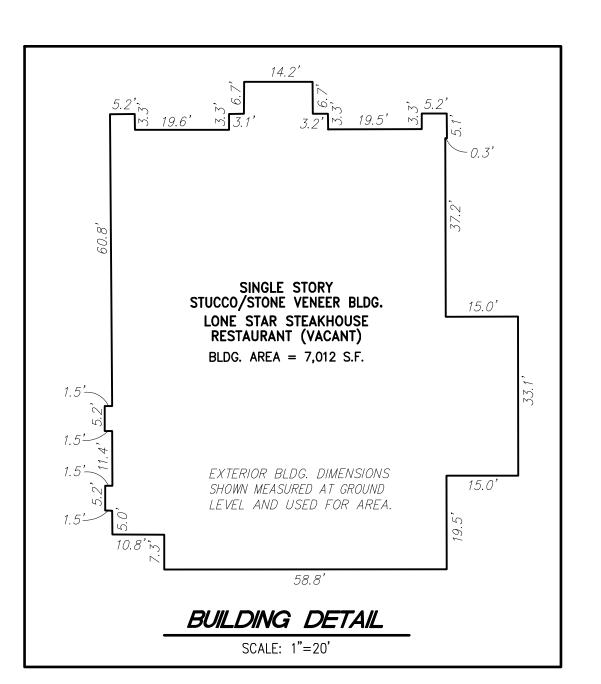







5200 Buffington Rd Atlanta Georgia, 30349-2998

Revisions: Mark Date By

Mark Date By

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JOSEPH C. TRUXAW & ASSOCIATES, INC.
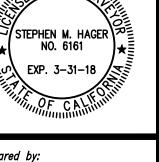
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CENTRAL AVENUE & DEXTER AVENUE
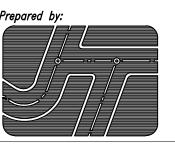
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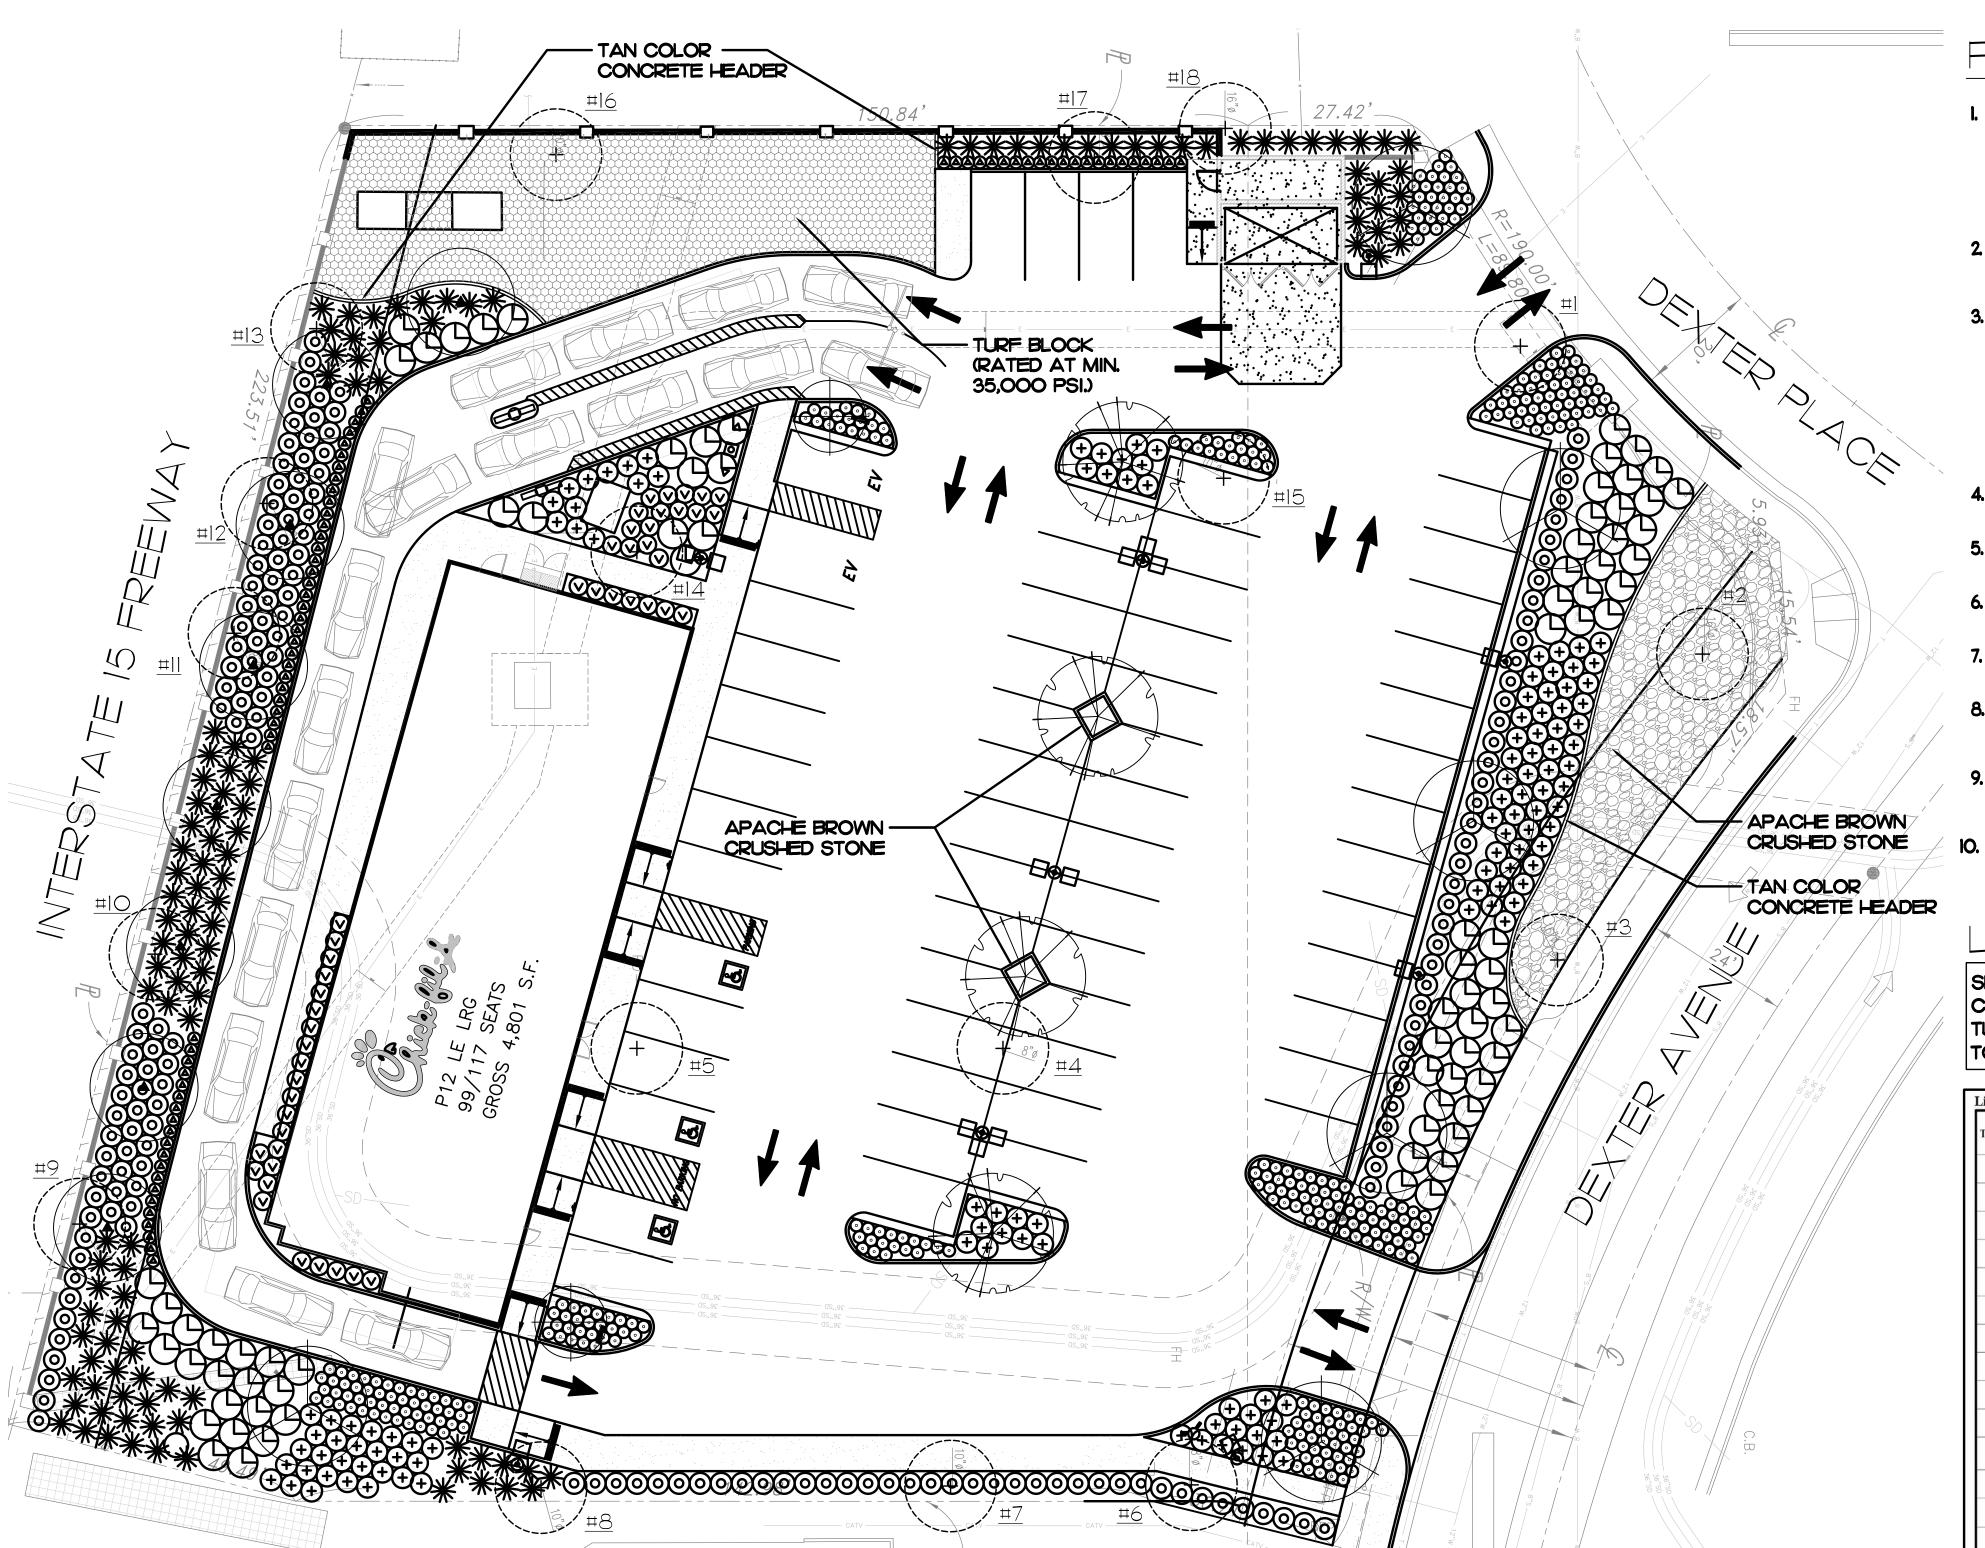
SHEET TITLE ALTA/NSPS LANI TITLE SURVEY

VERSION: ISSUE DATE:

Job No. : <u>CFA0610</u> : <u>#</u>04261 Store . 01-04-18

Drawn By : SDS

Checked By: SMH Sheet



PLANTING NOTES

- CONTRACTOR IS TO REVIEW PLANS, VERIFY SITE CONDITIONS AND PLANT QUANTITIES PRIOR TO INSTALLATION. CONFLICTS BETWEEN THE SITE AND THESE PLANS OR WITHIN THESE PLANS SHALL BE BROUGHT TO THE ATTENTION OF THE OWNER'S AUTHORIZED REPRESENTATIVE PRIOR TO LANDSCAPE INSTALLATION. ANY DEVIATION(S) FROM THE PLANS OR SPECIFICATIONS IS TO HAVE WRITTEN APPROVAL
- 2. ALL PLANT MATERIAL SHALL BE IN ACCORDANCE WITH THE LATEST EDITION OF "AMERICAN NURSERY AND LANDSCAPE ASSOCIATION" STANDARDS. WWW.ANLA.ORG
- 3. THE LANDSCAPE CONTRACTOR SHALL MAINTAIN ALL PLANTED AREAS BY MEANS OF CONTINUOUS WATERING, PRUNING, RAISING TREE BALLS WHICH SETTLE BELOW GRADE, FERTILIZING, APPLICATION OF SPRAYS WHICH ARE NECESSARY TO KEEP THE PLANTINGS FREE OF INSECTS AND DISEASES, WEEDING, AND/OR OTHER OPERATIONS NECESSARY FOR PROPER CARE AND UPKEEP. THE LANDSCAPE CONTRACTOR SHALL MAINTAIN ALL PLANTINGS AS SPECIFIED ABOVE FOR A PERIOD OF NINETY (90) DAYS.
- 4. LANDSCAPE ARCHITECT SHALL APPROVE PLANT MATERIAL PLACEMENT BY CONTRACTOR PRIOR TO INSTALLATION.
- 5. FERTILIZER FOR ALL PLANTING AREAS SHALL BE AS SPECIFIED WITHIN THE SOILS REPORT.
- 6. ANY TREES WITHIN 5' OF PAVING, CURBS, WALLS, BUILDINGS, ETC. TO BE INSTALLED WITH A ROOT BARRIER DEVICE.
- 7. FINISH GRADE TO BE 2" BELOW TOP OF CURB OR SIDEWALK FOR PLANTING AREAS.
- 8. CONTRACTOR TO INCLUDE IN HIS BID THE REPAIR OF ANY AND ALL DAMAGE RESULTING FROM INSTALLATION OF PLANTING ITEMS. CONNECT TO EXISTING CONDITIONS.
- 9. ALL PLANTING AND IRRIGATION ON THIS PROJECT TO MEET OR EXCEED CITY OF LAKE ELSINORE, CA LANDSCAPE GUIDELINES, STANDARDS AND AGENCY REQUIREMENTS.
- ALL PLANTER AREAS SHALL BE TOP DRESSED WITH 3" MINIMUM MULCH COVER UNLESS SPECIFIED OTHERWISE PER PLANS AND SPECIFICATIONS AS APPROVED BY THE LANDSCAPE ARCHITECT.

LANDSCAPE CALCULATIONS

	SHRUB AREA:	10,949 S.F.
/	CRUSHED STONE:	1,560 S.F.
/	TURF AREA:	2,425 S.F.
	TOTAL LANDSCAPE AREA:	13,544 S.F.

Tree #	Common Name	Botanical Name	Diameter at 4.5 feet (dbh) In inches	Height (in feet)	Spread (in feet)	Physiological condition	City Tree Yes or No
1	Eucalyptus sideroxylon	Ironbark eucalyptus	14.5	48	21	good	no
2	Eucalyptus sideroxylon	Ironbark eucalyptus	14	40	20	good	no
3	Eucalyptus sideroxylon	Ironbark eucalyptus	15	45	25	good	no
4	Canary island pine	Pinus Canariensis	6	17	8	good	no
5	Canary island pine	Pinus Canariensis	5	16	8	good	no
6	Canary island pine	Pinus Canariensis	5.5	16	8	good	no
7	Eucalyptus sideroxylon	Ironbark eucalyptus	11	22	12	good	no
8	Eucalyptus sideroxylon	Ironbark eucalyptus	10	25	18	good	no
9	Eucalyptus sideroxylon	Ironbark eucalyptus	13	38	18	good	no
10	Eucalyptus sideroxylon	Ironbark eucalyptus	13	35	18	good	no
11	Eucalyptus sideroxylon	Ironbark eucalyptus	8	20	15	dead	no
12	Canary island pine	Pinus Canariensis	5	11	8	good	no
13	Eucalyptus sideroxylon	Ironbark eucalyptus	11	35	15	good	no
14	Canary island pine	Pinus Canariensis	5	20	8	good	no
15	Canary island pine	Pinus Canariensis	5	20	8	good	no
16	Eucalyptus sideroxylon	Ironbark eucalyptus	15	40	28	good	no
17	Canary island pine	Pinus Canariensis	6	20	8	good	no
18	Eucalyptus sideroxylon	Ironbark eucalyptus	15	45	20	good	no

PLANTING LEGEND

SYMBOL TOP	BOTANICAL NAME ES	COMMON NAME	SIZE QTY.	<u>REMARKS</u>	WUCOLS REGION 4
ATT (X+)	EXISTING TO BE REMOVED	FIELD VERIFY	EXISTING 18	SEE NOTES BE	
	CERCIDIUM 'DESERT MUSEUM'	DESERT MUSEUM PALO VERDE	24" BOX 4	STANDARD	LOW
	CERCIS OCCIDENTALIS 'CLAREMONT'	WESTERN REDBUD	24" BOX 2	STANDARD	LOW
	LAURUS NOBILIS 'MOHUM'	SWEET BAY	24" BOX 8	STANDARD	LOW
	RHUS LANCEA	AFRICAN SUMAC	24" BOX 6	STANDARD	LOW
1	^				

	<u>SHRUE</u>	BS/GROUNDCOVERS					
0	A	LOE STRIATA	CORAL ALOE	5 GAL.	325	2'-O" O.C.	LOW
0	C	ALLISTEMON V. 'LITTLE JOHN'	DWARF WEEPING BOTTLEBRUSH	5 GAL.	170	3'-6" O.C.	LOW
	D	IANELLA 'LITTLE REV'	LITTLE REV FLAX LILY	5 GAL.	21	2'-0" O.C.	LOW
\odot	D	IANELLA TASMANICA 'VARIEGATA'	VARIEGATED FLAX LILY	5 GAL.	72	3'-O" O.C.	MOD
*	D	IETES VEGETA	FORTNIGHT LILY	5 GAL.	126	4'-0" O.C.	MOD
\bigcirc	L	ANTANA 'NEW GOLD'	TRAILING YELLOW LANTANA	I GAL.	82	5'-O" O.C.	LOW
(+)	_ м	UHLENBERGIA CAPILLARIS	PINK MUHLY GRASS	5 GAL.	127	3'-6" O.C.	MOD
	C	RUSHED STONE	'APACHE BROWN'	3/4" -	1,560 S.F.	MIN. 2" LAYER	
		FWAY 419 I TURF BLOCK	BERMUDA HYBRID TURF BLOCK TO BE DETERMINED	SOD	2,425 S.F.	AVAILABLE FROM PACIFIC SOD (805) 986-8277	М







hourian associates, in

107 avenida miramar, suite d

san clemente, california 92672 p: 949.489-5623 efax: 877.271.3122

e: team@hourianassociates.com



5200 Buffington Rd

Atlanta Georgia,

30349-2998

Revisi	ons:	
Mark	Date	By

Mark Date By

Mark Date By






STORE Central ave & DEXTER AVE.

18601 DEXTER AVE LAKE ELSINORE, CA

SHEET TITLE PRELIMINARY LANDSCAPE PLAN

VERSION: V7.0 ISSUE DATE: 08-20


Job No. • <u>04261</u> Store • 2-28-18 Drawn By : mdm Checked By: JHA

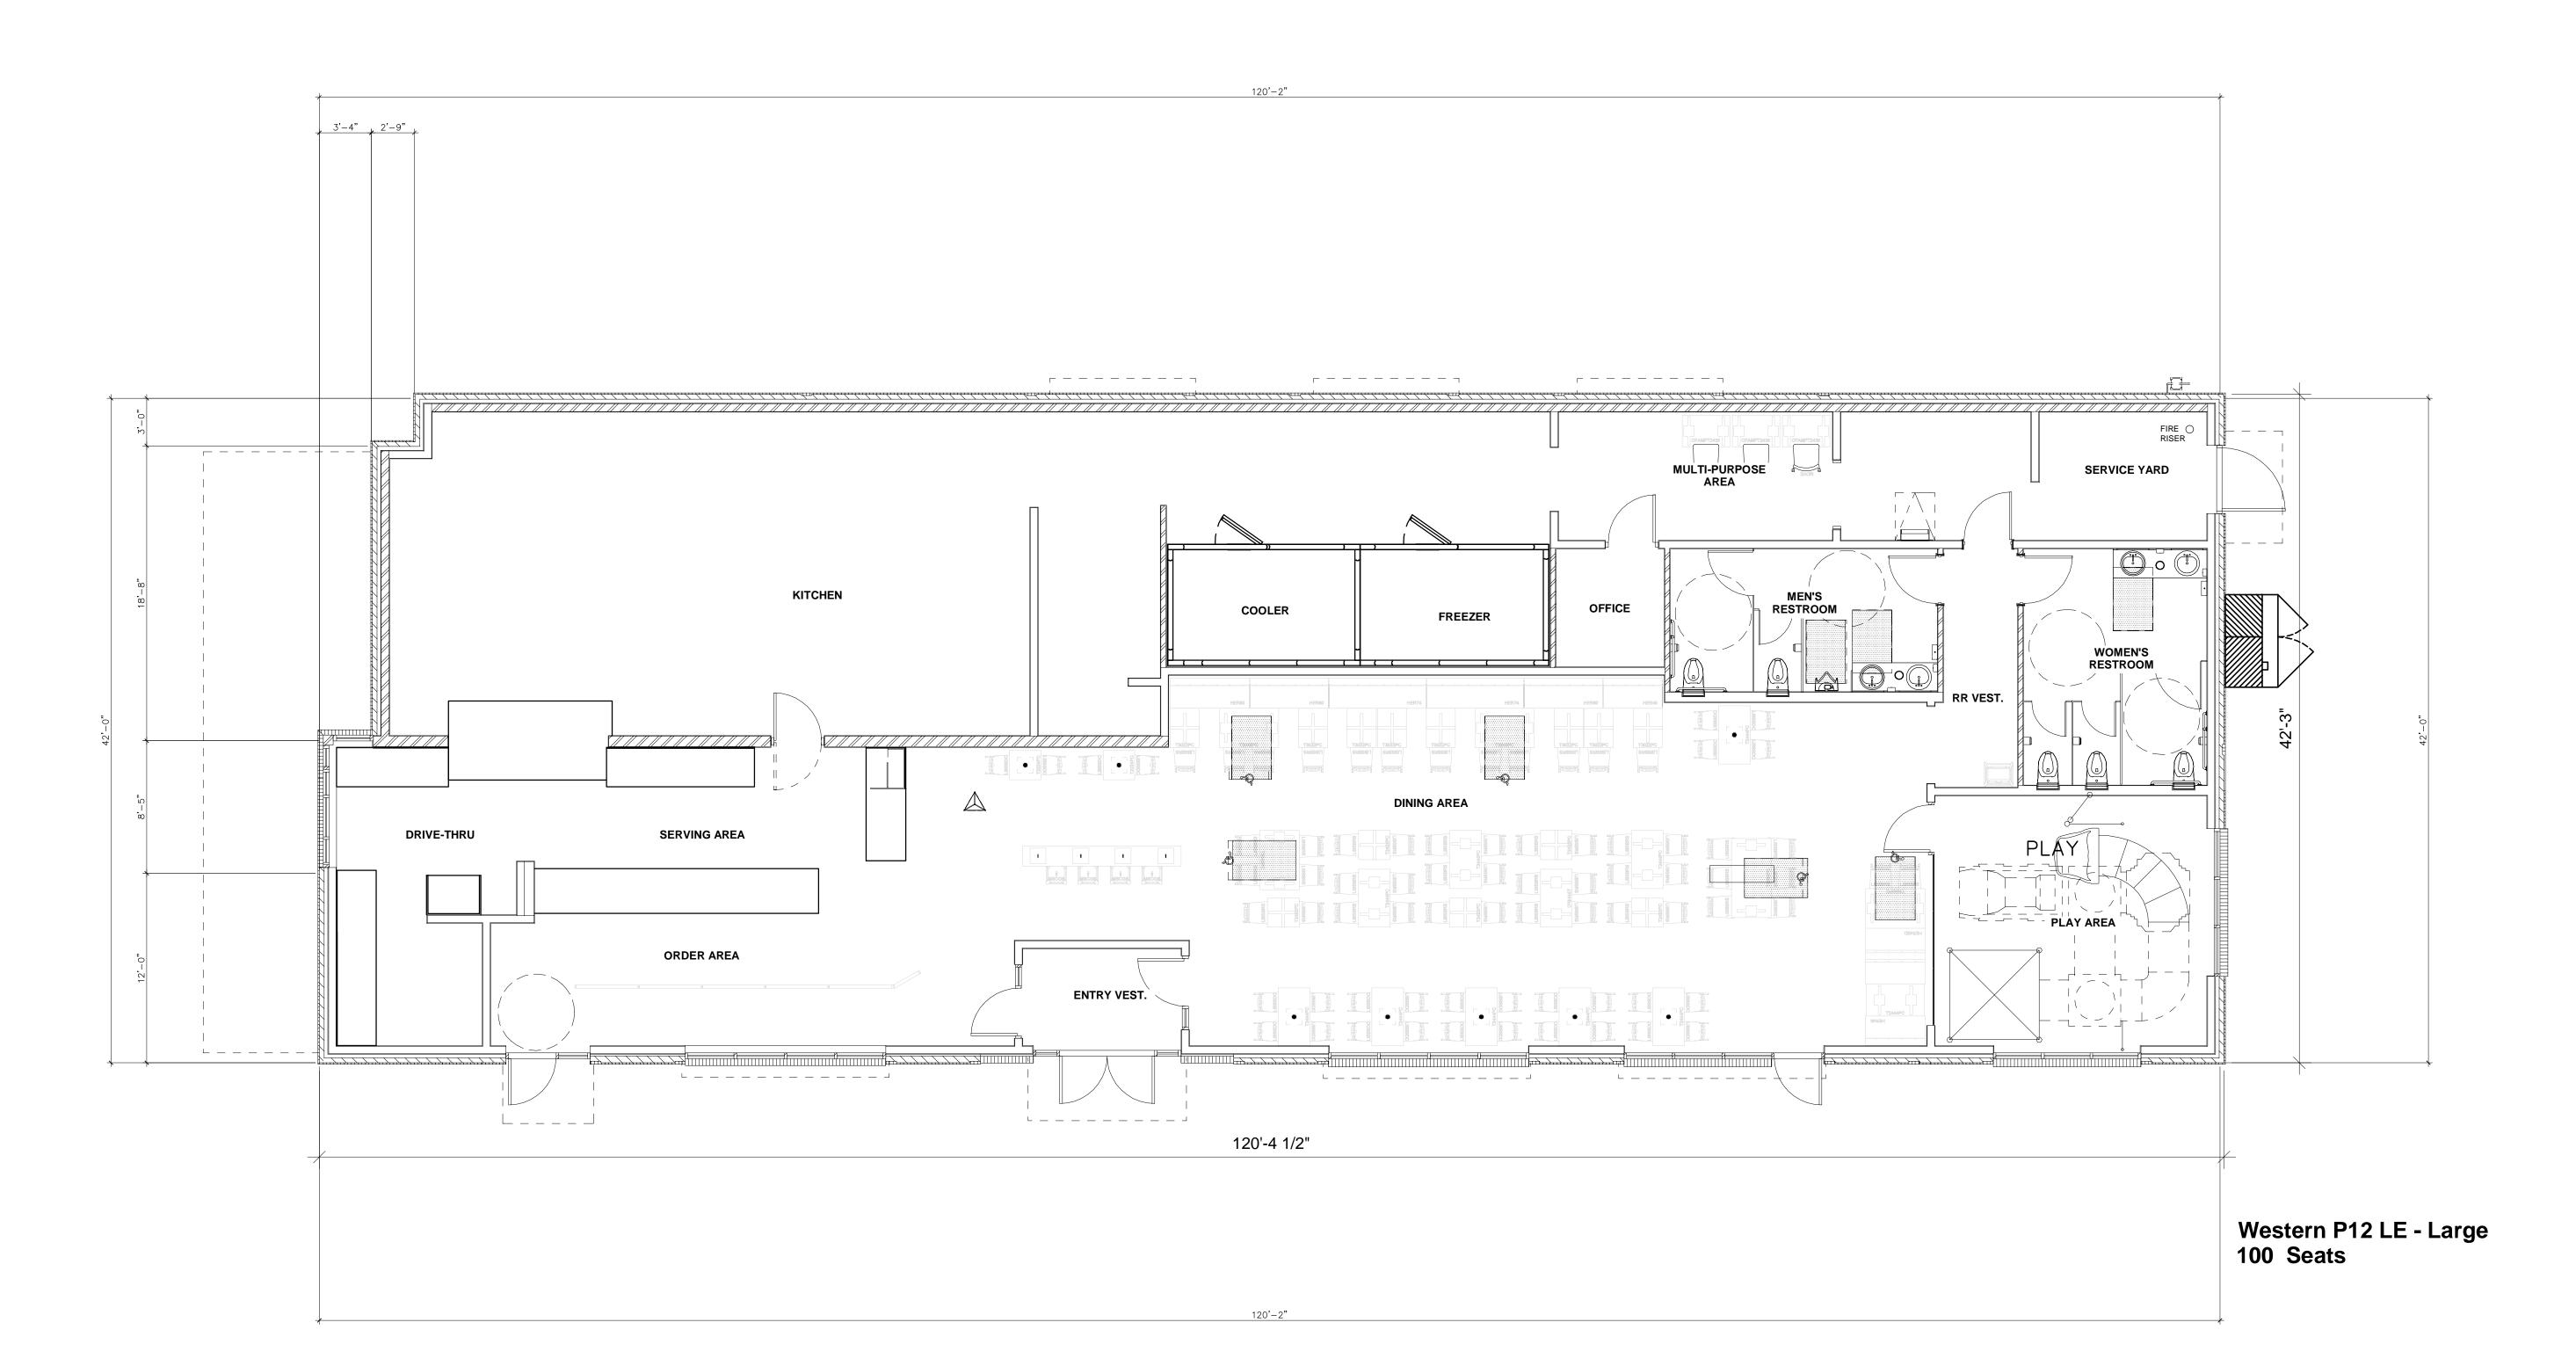

STATISTICS (NET) SQUARE FOOTAGE BREAKDOWN: ENTRY DINING PLAY WOMEN 61 SF 1247 SF 270 SF 173 SF 72 SF 185 SF 148 SF 51 SF 139 SF 1368 SF 244 SF 194 SF 302 SF 4455 SF RR VEST SERVICE MEN
OFFICE
MULTI-PURPOSE KITCHEN SERVING DRIVE-THRU QUEING NET TOTAL

FLOOR PLAN



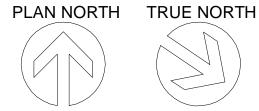



5200 Buffington Rd. Atlanta Georgia, 30349—2998

Mark Date By

Mark Date By



STORE CENTRAL AVE & DEXTER AVE.

18601 DEXTER AVE. LAKE ELSINORE, CA

SHEET TITLE FLOOR PLAN

VERSION: V7.025 ISSUE DATE: 08-2016


Job No. : <u>17-200</u> : __04261 : <u>03-07-18</u> Drawn By :____

Checked By: <u>R.H.</u>

A-I.O



- CRICKETS SHALL BE CONSTRUCTED OF RIGID INSULATION AS REQUIRED TO PROVIDE SLOPE OF I/8" PER FOOT MIN.
- 2. PAINT ALL EXPOSED GAS PIPING ON ROOF DARK BRONZE (2 COATS).
- ALL CONDENSATE LINES SHALL BE INSTALLED TO PROVIDE POSITIVE DRAINAGE. GENERAL CONTRACTOR SHALL PROVIDE BLOCKING AS REQUIRED TO ELIMINATE SAGGING.
- 4. NOT USED.
- 5. HORIZONTAL ROOFING MEMBRANE(S) SHALL BE WHITE.
- 6. VERTICAL ROOFING MEMBRANE(S) SHALL BE TAN.
- 7. WALK-PAD MEMBRANES SHALL BE GRAY.
- 8. THICKNESS REQUIRED FOR RIGID ROOF INSULATION BOARD TO MEET REGIONAL ENERGY REQUIREMENTS. RE: SPECIFICATIONS
 NOTE TO GC: R-VALUE MAY VARY DEPENDING ON MANUFACTURER. ESTIMATE R-5.5 PER INCH OF THICKNESS.

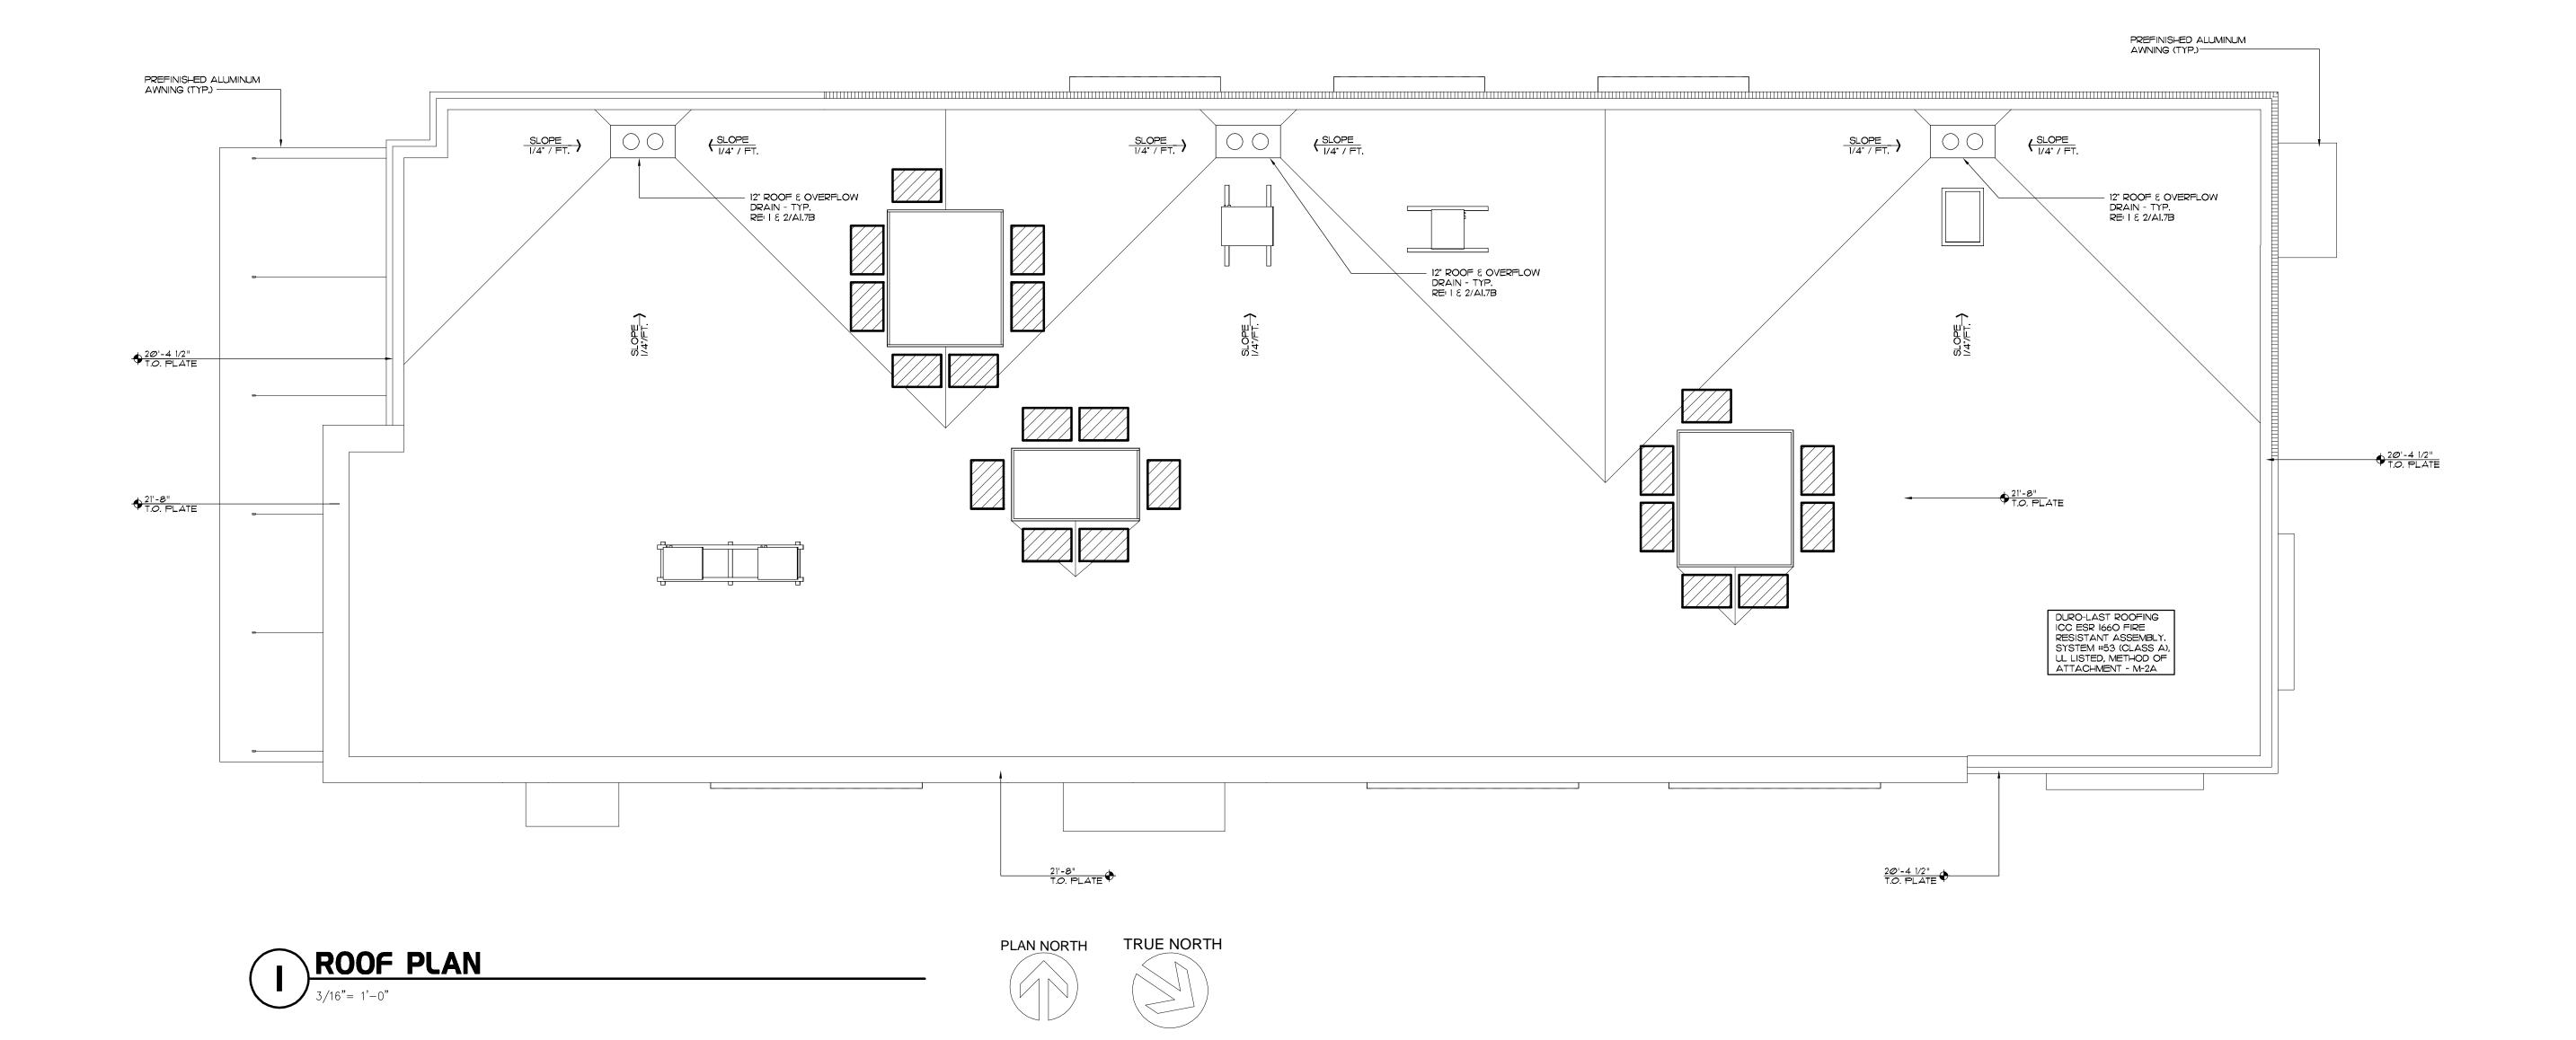



Chick-fil-1

5200 Buffington Rd. Atlanta Georgia, 30349—2998

Revisions: Mark Date By

____ Mark Date By

Mark Date By

Seal



CENTRAL AVE &
DEXTER AVE.

phone 714.832.1834

18601 DEXTER AVE. LAKE ELSINORE, CA

ROOF PLAN


VERSION: V7.025 ISSUE DATE: 08-2016


Job No. : <u>17-200</u> Store : <u>04261</u> Date : <u>03-07-18</u>

Drawn By : ____ Checked By: _____R.H._

CHECKEU L

A-I.7

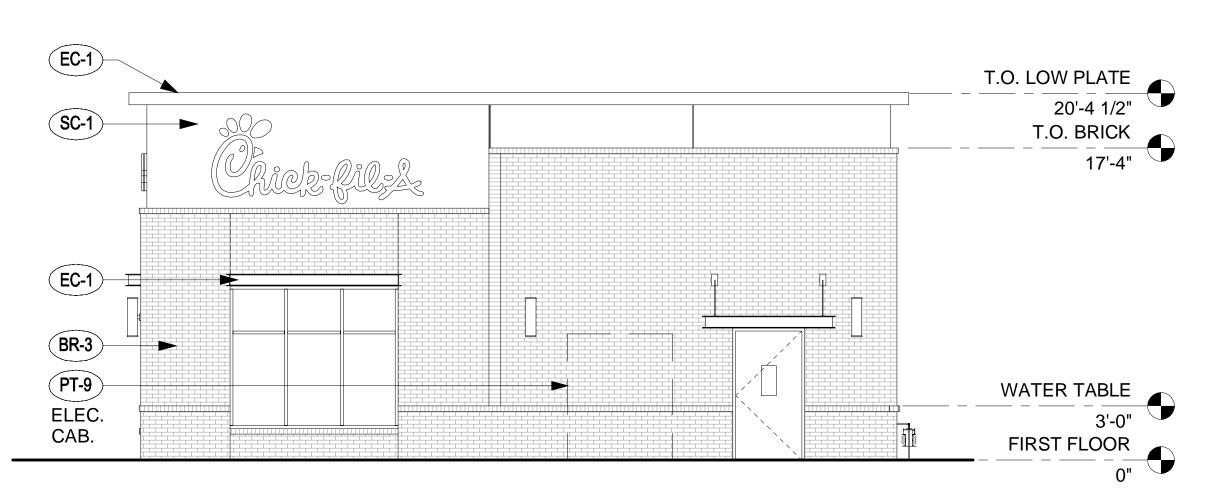

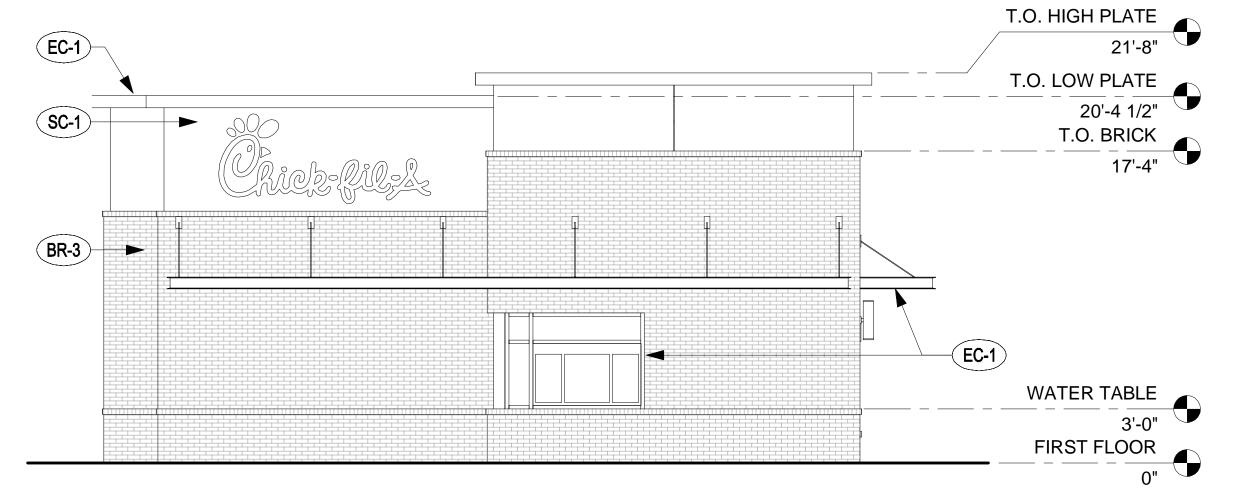

EXTER	IOR FINISHES - FOR STOREFRONT GLAZING, SEE GLASS SCHED. & INT. ELEV.
BR-3	BRICK VENEER BORAL BRICK— MODULAR, COLOR CITADEL MORTAR: ARGOS SAN TAN
EC-1	PREFINISHED METAL COPING COLOR — DARK BRONZE
SC-1)	STUCCO COLOR — WHITE FINISH — SAND MEDIUM
PT-1	PAINT #1 COLOR — DARK BRONZE
A-1	ALUMINUM AWNING — PRE—FIN. COLOR — DARK BRONZE 1'—O" DEEP
(A-2)	ALUMINUM AWNING — Pre-fin. color — dark bronze 4'—o" deep
(A-3)	ALUMINUM AWNING — Pre-fin. color — dark bronze 5'-o" deep
PT-9	PAINT #1 COLOR — TO MATCH BRICK "CITADEL"

NORTH ELEVATION

3/16"= 1'-0"


SOUTH ELEVATION


3/16"= 1'-0"



EAST ELEVATION

3/16"= 1'-0"

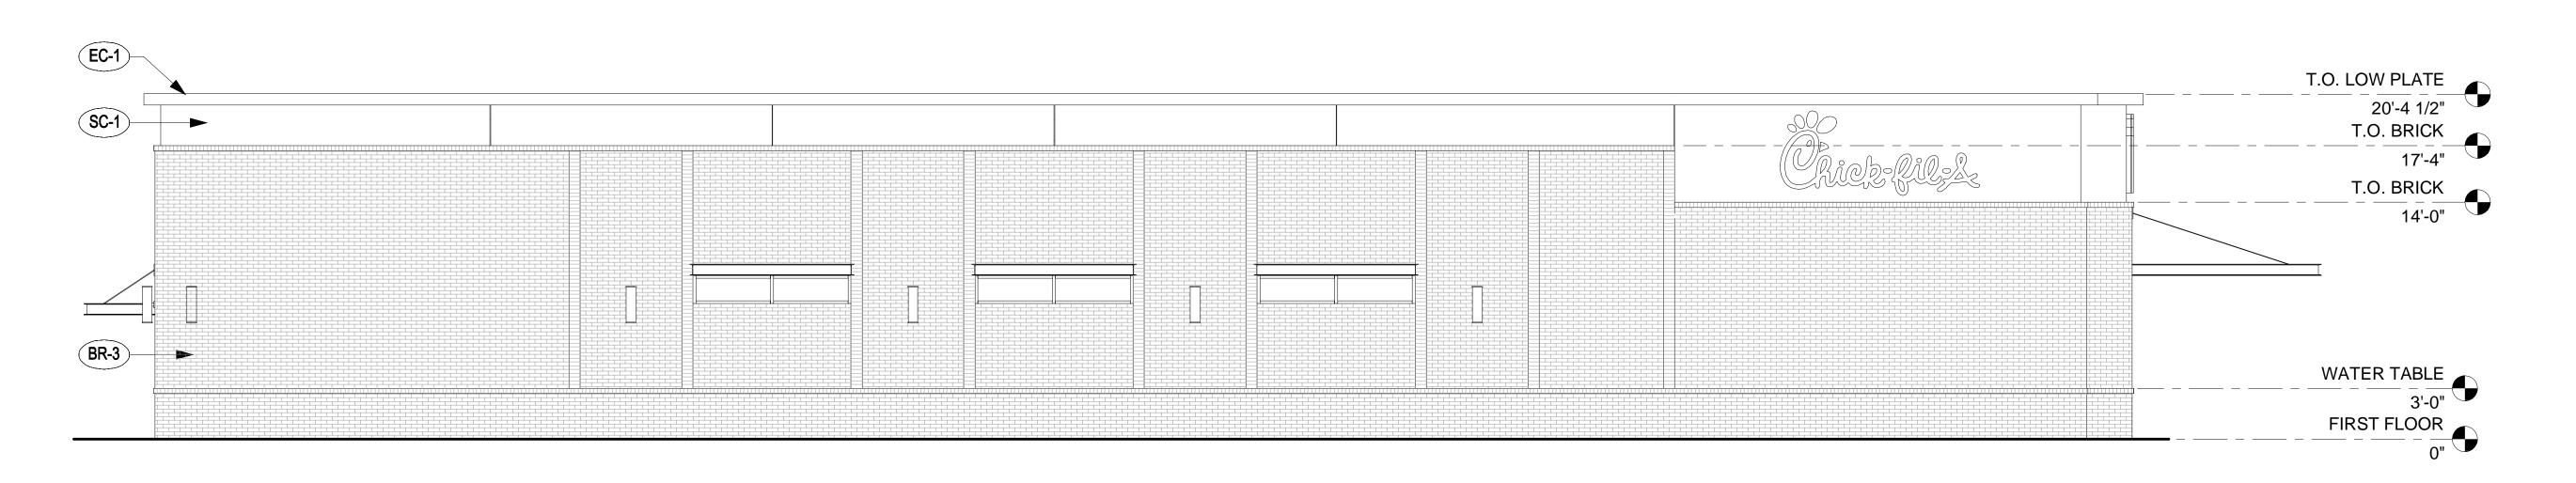

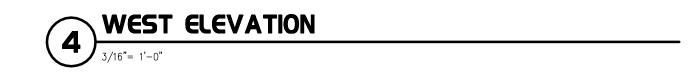



5200 Buffington Rd. Atlanta Georgia, 30349-2998

Revisions: Mark Date By

Mark Date By

Mark Date By

Seal



STORE
CENTRAL AVE &
DEXTER AVE.

18601 DEXTER AVE. LAKE ELSINORE, CA

SHEET TITLE
EXTERIOR
ELEVATIONS

VERSION: V7.025 ISSUE DATE: 08-2016

 Job No.
 : 17-200

 Store
 : 04261

 Date
 : 03-07-18

 Drawn By
 : ____

Checked By: R.H.

A-2.I

Örick-fil-1

5200 Buffington Rd. Atlanta Georgia, 30349—2998

30349-2998 Revisions:

Mark Date By

Mark Date By

Mark Date By

Seal



STORE
CENTRAL AVE &
DEXTER AVE.

18601 DEXTER AVE. LAKE ELSINORE, CA

SHEET TITLE
BUILDING
SECTION

VERSION: V7.025 ISSUE DATE: 08-2016

 Job No.
 : 17-200

 Store
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 : 03-07-18

 Drawn By
 : ____


Checked By: R.H.

Sheet

A-3.I



SOUTH ELEVATION

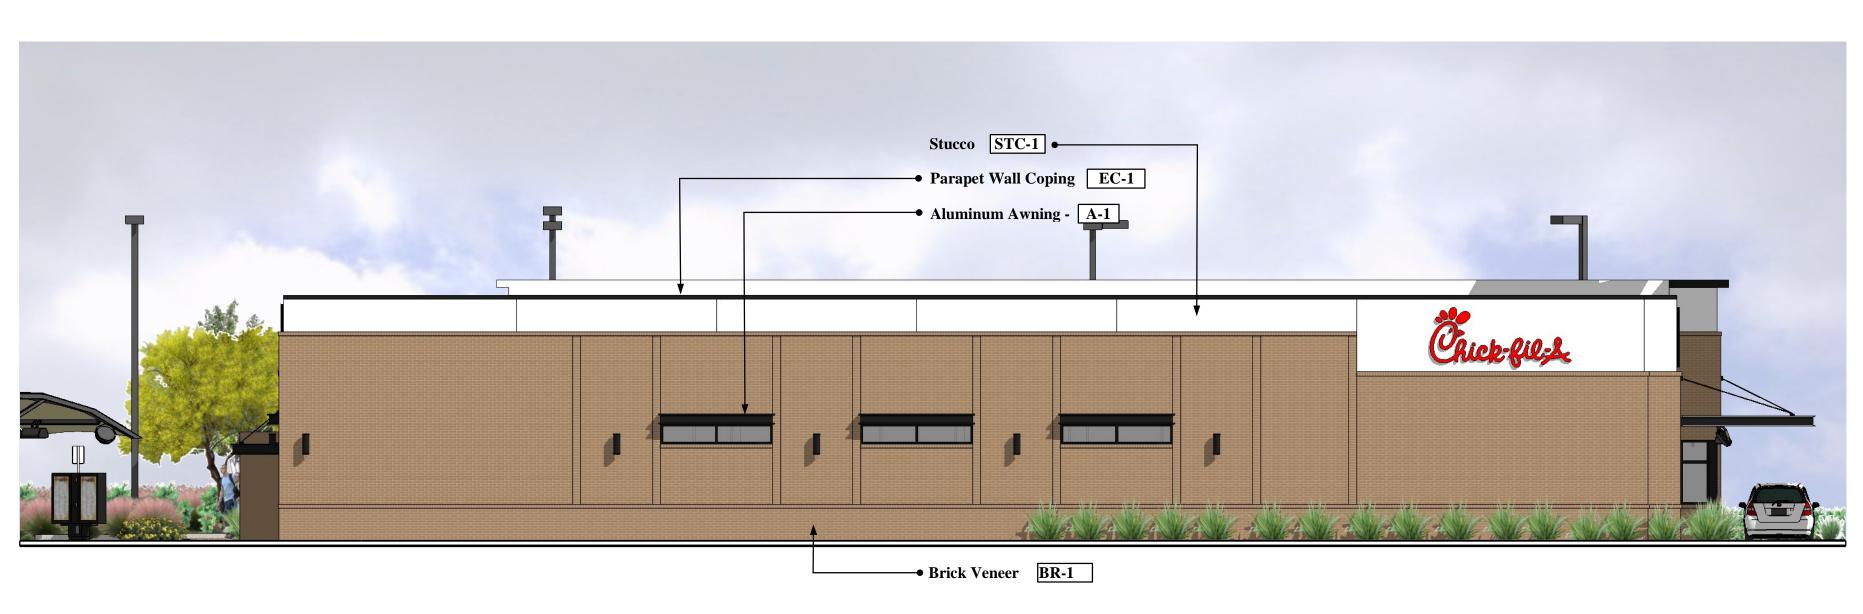

WEST ELEVATION



NORTH ELEVATION



EAST ELEVATION



PRELIMINARY ELEVATIONS 18601 Dexter Ave. Lake Elsinore, CA

All roof top mechanical equipment shall be located in equipment well and screened from view by parapet walls.

COLOR AND MATERIAL LEGEND


STC-1 Stucco - STO - Powerwall "White"

BR-1 Brick Veneer - Boral Brick - Color: Citadel

EC-1 Parapet Wall Coping - Durolast/Exceptional Metals - Dark Bronze (Matte)

A-1 Aluminum Awning - Color: Dark Bronze



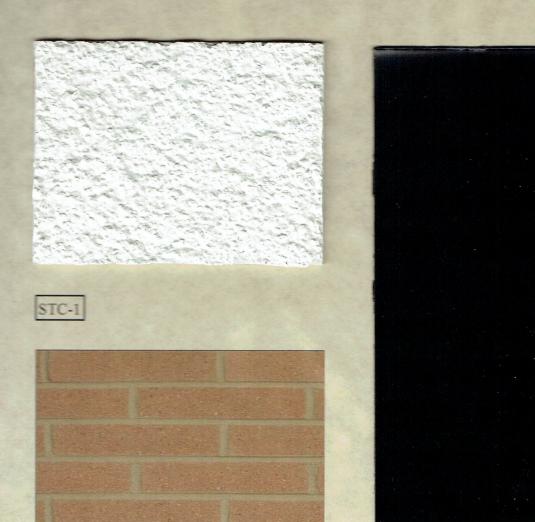

BR-1

EC-1 A-1



COLORS & MATERIALS Lake Elsinore, CA (17-200) 03-07-18

COLOR AND MATERIAL LEGEND

STC-1 Stucco - STO Powerwall "White"

BR-1 Brick Veneer - Boral Brick - Color "Citadel

EC-1 Parapet Coping - Durolast/Exceptional Metals-Dark Bronze (Matte)

A-1 Aluminum Awning - Color: Dark Bronze



SOUTHWEST VIEW



03-07-18





SOUTHEAST VIEW



03-07-18





NORTHWEST VIEW







NORTHEAST VIEW



