



SCALE 1" = 10'

LOT 18, COUNTRY CLUB HEIGHTS, UNIT # 6 M.B. 12 / 68-69 (A.P.N. 373-182-018)

SURVEYOR


BOYD SCHNEIDERWENT P.L.S. 9099 ROCHESTER ROAD PHELAN CA 92371

760-868-0346 / 909-980-3701 FAX 760-868-3027


E-MAIL schneiderwent@hotmail.com





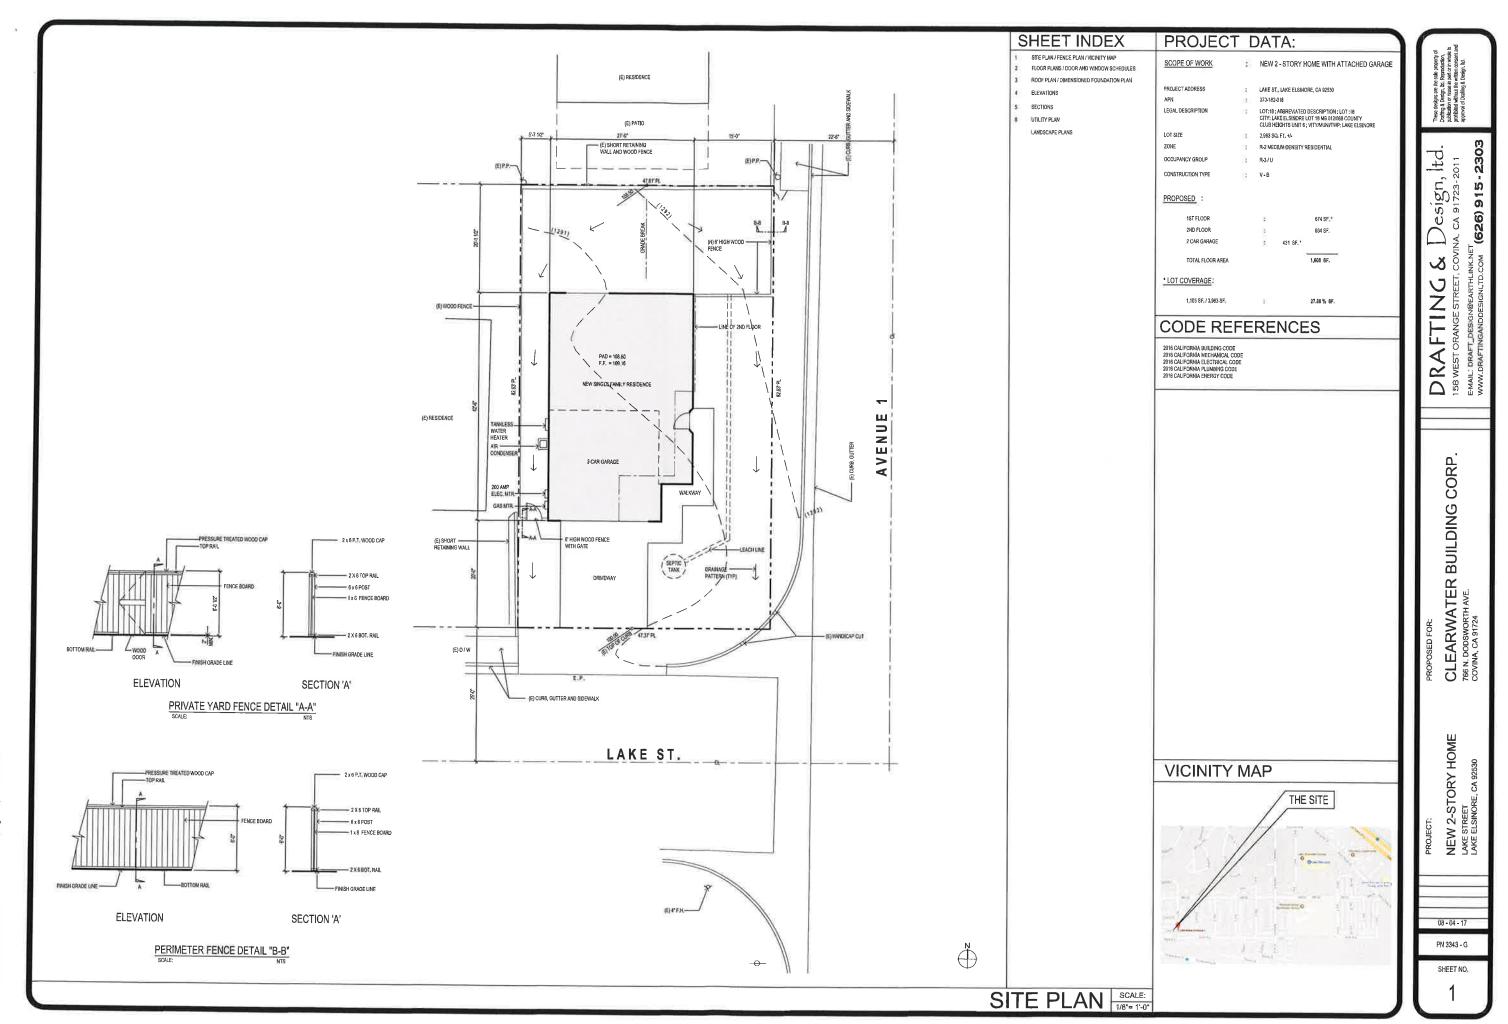

r\data\AutoCad\PROJECTS\2017\Gil Valdez 3343-G\Base Plan.dwg, 12/13/2017 8:14:29 AM

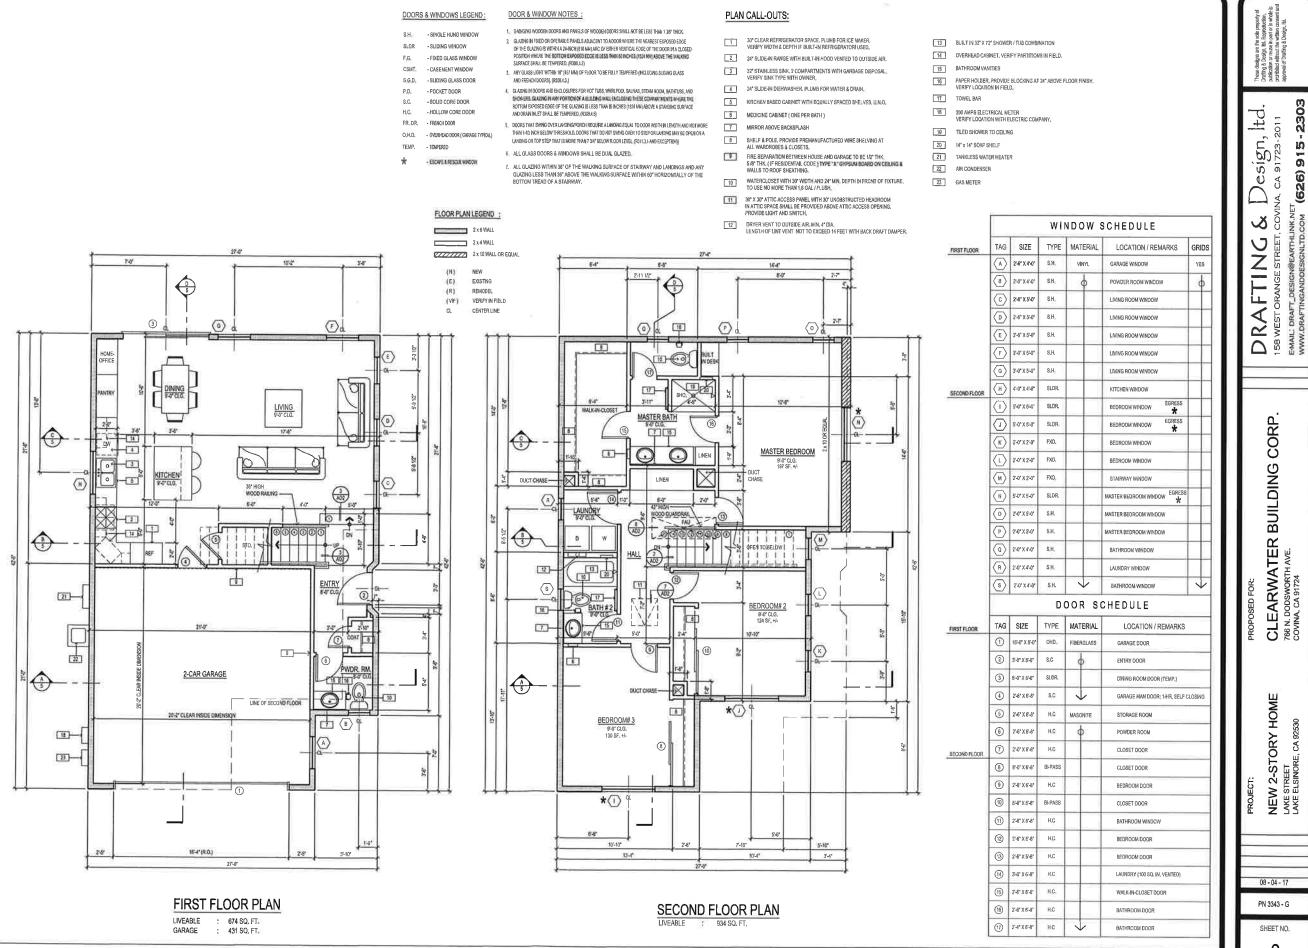


server\data\AutoCad\PROJECTS\2017\Gil Valdez 3343-G\Base Plan dwn 12/13/2017 8·14-59 AM

FLOOR PLANS SCALE: 1/4"= 1/40"

l)

2

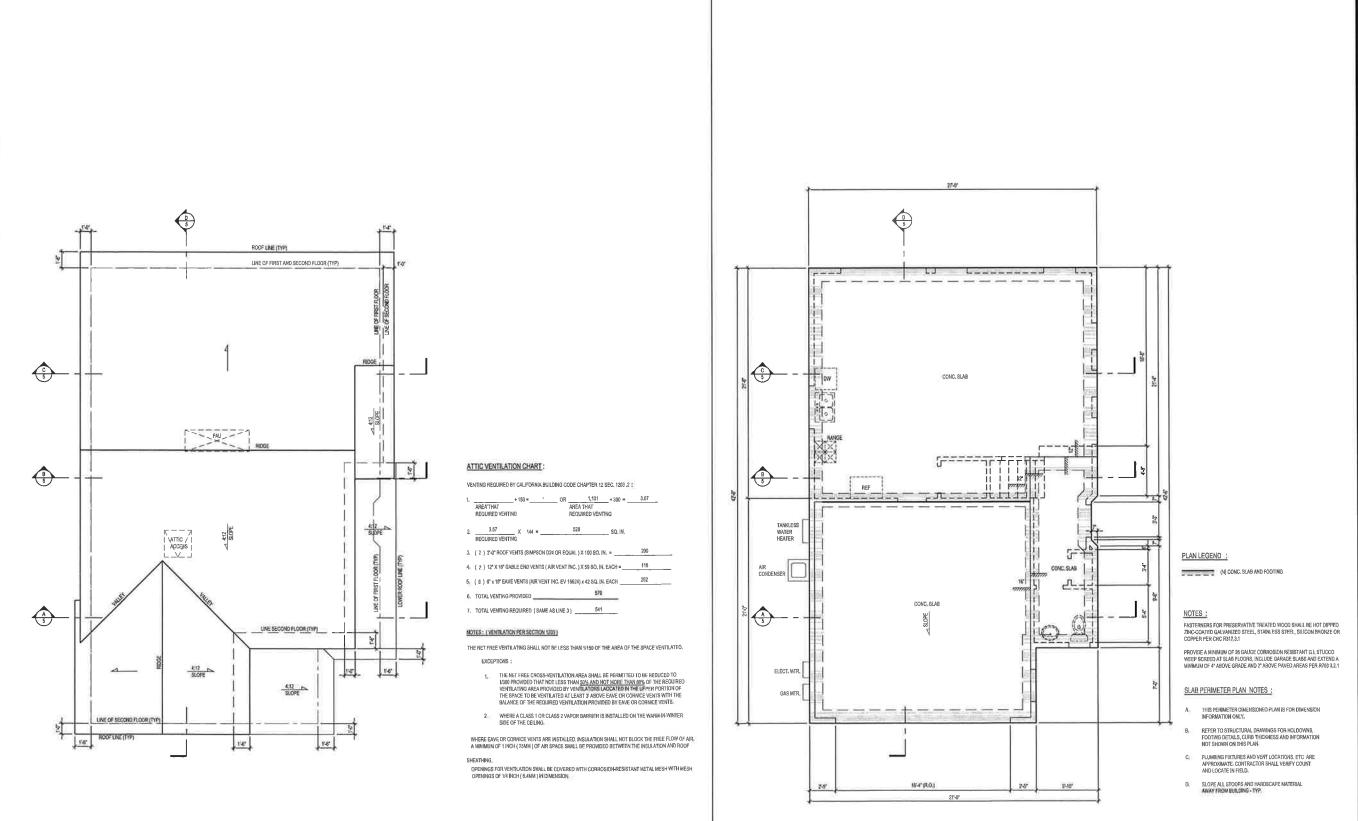

Design, ltd.

S DRAFTING

CORP.

CLEARWATER BUILDING 766 N. DODSWORTH AVE. COVINA, CA 91724


NEW 2-STORY HOME LAKE STREET LAKE ELSINORE, CA 92530

08 - 04 - 17 PN 3343 - G

SHEET NO.

ROOF PLAN SCALE: 1/4"= 1"+0"



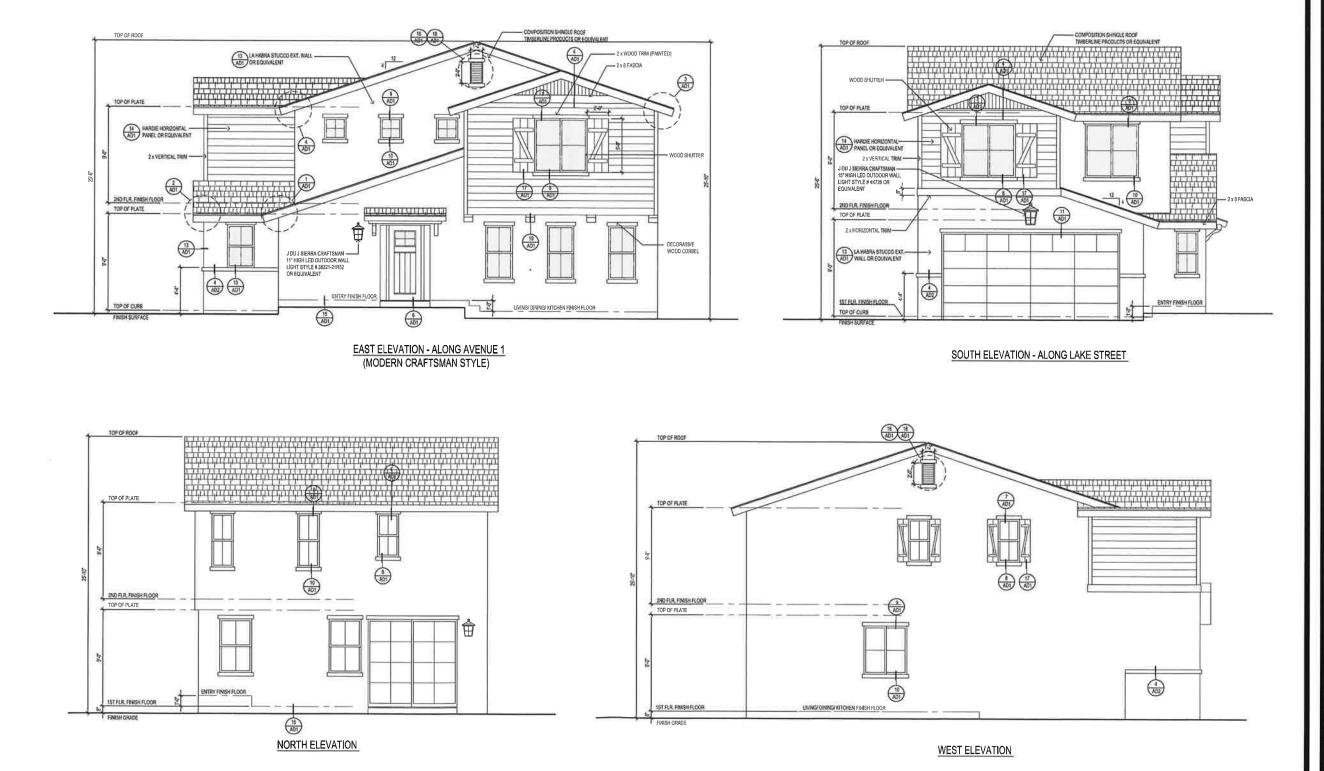

DRAFTING
158 WEST ORANGE STREET, C
EMAIL; DRAFT DESIGN@EARTHLIN
WWW.DRAFTINGANDAGE CORP.

Design, ltd.

Ø

(626) 915-2303

CLEARWATER BUILDING 766 N. DODSWORTH AVE. COVINA, CA 91724

NEW 2-STORY HOME LAKE STREET LAKE ELSINORE, CA 92530

08 - 04 - 17 PN 3343 - G

SHEET NO.



NORTH ELEVATION



WEST ELEVATION



EAST ELEVATION - ALONG AVENUE 1



SOUTH ELEVATION - ALONG LAKE STREET

NEW 2-STORY HOME LAKE STREET LAKE ELSINORE, CA 92530

CLEARWATER BUILDING CORP. 766 N. DODSWORTH AVE. CONINA, CA 91724


(626) 915-2303

DRAFTING & Design, Itd.
158 WEST ORANGE STREET. COVINA. CA 91723-2011
EMALL DRAFT DESIGN@EARTHUNKNET
WWW.DRAFTINGANDDESIGNLTD.COM (626) 915-2303

08 - 04 - 17

PN 3343 - G SHEET NO.

ELEVATIONS SCALE: 1/4"= 1"-0"

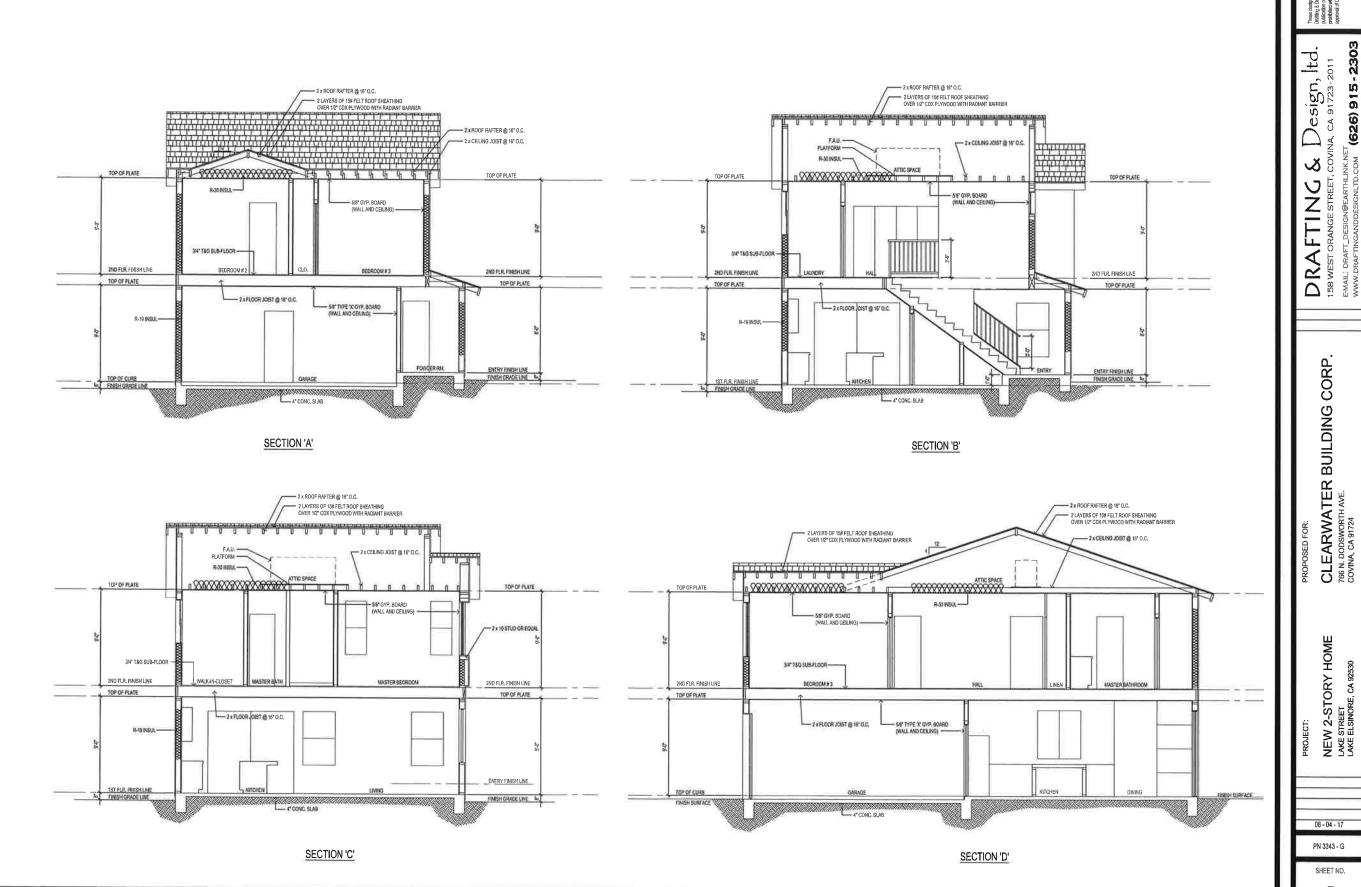

SECTIONS SCALE: 1/4"= 1'-0'

NEW 2-STORY HOME LAKE STREET LAKE ELSINORE, CA 92530

(626) 915-2303

08 - 04 - 17 PN 3343 - G

SHEET NO.

SHALL BE CONTECTED IN THE MAJORITUS CHARLES OF AREA GIVING ACCESS TO EACH SEPARATE SLEEPING AREA.

B. IN EACH BASEMENT.

C. ON EACH STORY OF MULTISTORY DWELLINGS.

ATTHE UPPER LEVEL OF SPAIL LEVEL DWELLINGS EXCEPT THAT WHEN THE LOWER LEVEL CONTAINS A SLEEPING ROOM, DETECTORS SHALL BE PROVIDED ON BATH LEVEL DWELLINGS. BOTH LEVELS.

BOTH LEVELS.
E. WHEN BLEEPING ROOMS ARE ON AN UPPER LEVEL THE DETECTOR SHALL BE AT THE CELING OF THE UPPER LEVEL IN CLOSE PROXAMINTY TO THE STARWAY. F. WHERE THE CELING NEIGHT OF A ROOM WHICH OPERS TO A HALLWAY SERVING SLEEPING ROOMS EXCEEDS THE CELILIAN BEIGHT OF THE HALLWAY BY 24 INCHES (616 MM), DETECTORS SHALL BE INSTALLE IN SONTH THE HEIGHT AND ORAS THE HIGH POINT OF THE ADJOINING ROOM, (APPLIES TO ROOMS WITH CATHERD ACTION CELINGS AND SMALL ROOMS (TONS).

G. IN EACH SLEEPING AREA. SECTION 310.0,1

\$MOKE DETECTORS MUST RECEIVE THEIR PRIMARY POWER FROM THE BUILDING WIRING AND SHALL BE EQUIPPED WITH A BATTERY BACK-UP. (310,9,1.3)

3, SMOKE DETECTORS ARE REQUIRED IN THE EXISTING PORTION OF THE OWNLLING, DETECTORS MUST BE INSTALLED AS REQUIRED BY THE 1998 UNIFORM BUILDING CODE. RETROFIT SMOKE DETECTORS MAY BE BATTERY OPERATED. SEC, 310,9.1

SMOKE ALARMS SHALL BE HARDWIRED WITH BATTERY BACKUP AND ALARMS INTERCONNECTED (R314.5).

DUPLEX OUTLET @12"ABOVE FLOOR (UNLESS NOTED OTHERWISE)

FLOOR DUPLEX OUTLET

€ 220 VOLT DUPLEX OUTLET

\$ SWITCH

Œ

GARBAGE DISPOSAL

CH CHIME

CHANDELIER / HANGING TYPE LIGHT

HB HOSE BIB

PER TITLE 24. VERIFY W/ H.V.A C. CONTRACTOR, PROVIDE PASSAGE

FROM SCUTTLE TO EQUIPMENT & CONTROLS, 30" MIN, HEAD CLEARANCE, (LENGTH NOT TO EXCEED 20 FT TYP.)

NOTES :

24" WIDEOF SOLID CONTINUOUS FLOORING

a, A PERMANENTLY WIRED ELECTRICAL OUTLET AND LIGHT FIXTURE FOR THE

F,A.U. b, LIGHT TO BE SWITCHED AT THE ACCESS

OPENING.

c. F.A.U., TO BE HARD WIRED WITH A SWITCH DISCONNECT.

__ICE ICE MAKER

LIGHT/ FUN COMBO

(30 SMOKE DETECTOR

CM CARBON MONOXIDE DETECTOR

UTILITY PLAN LEGEND :

HALF HOT DUPLEX OUTLET

\$D SWITCH WITH DIMMER

\$3 3 WAY SWITCH

◆
¶PH PHONE JACK

√TV TELEVISION ANTENNA OR
TELEVISION CABLE JACK

BRACKET LIGHT (* 5'-6" ABOVE FLOOR ON ENTRY , 6'-8" ABOVE FLOOR AT SIDE OR REAR, VERIFY IN FIELD) +\$

FLOURESCENT LIGHTING

CEILING LIGHT OUTLET (SURFACE MOUNT)

CAN LIGHT

EYEBALL LIGHT

SERVICE POWER PANEL

SC WALL SCONCE

Output

Description

Output

G GARAGE DOOR OPENER

-CHIMES / DOORBELL PUSH BUTTON

HEATING AND FAN COMBO

FG FUEL GAS

FIREPLACE KEY (LOOSE)

SUPPLY AIR / HEATING REGISTER

UNDER CABINET
FLOURESCENT LIGHTING

QFI GROUND FAULT INTERRUPTER

AFI ARC FAULT INTERRUPTER

FB FAN BOX

MST MOTION SENSOR WITH TIMER

HOOD LIGHT AND FAN (100 CFM MIN.)

CARBON MONOXIDE:

OUTSIDE OF EACH SEPARATE DWELLING UNIT SLEEPING AREA IN THE IMMEDIATE VICINITY OF THE BEDROOM(S). CRC R315.3.

2. ON EVERY LEVEL OF A DWELLING UNIT INCLUDING BASEMEN

CARBON MONOXIDE CETECTOR SHALL BE INTERCONNECTED SUCH THAT THE ACTIVATION OF ONE ALARM WILL ACTIVATE ALL ALARMS.

4, CARBON MONOXIDE DETECTORS SHALL BE "HARDWIRED" AND SHALL BE EQUIPPED WITH BATTERY BACKUP.

ARC FAULT CIRCUIT INTERRUPTOR CONNECTIONS:

ALL BRANCH CIRCUITS THAT SUPPLY 125 VOLT, SINGLE PHASE, AS AND 20 AMPERE OUTLETS INSTALLED IN DWELLING UNITS SHALL BE PROTECTED BY AN ARC-FAULT CIRCUIT INTERRUPTER(8), CEC 210,12, ARC FAULT CIRCUIT INTERRUPTERS IS NOW REQUIRED FOR ALL NEW OUTLETS, MOT JUST BEDROOMS,

MECHANICAL / PLUMBING/ ELECTRICAL REQUIREMENTS;

A. GAS - FIRED WATER HEATERS SHALL COMPLY WITH THE FOLLOWING

A.I WATER HEATER MUST BE STRAPPED AT UPPER ONE-THIRD (1/3) AND THE LOWER ONE-THIRD (1/3) FOR LATERAL SUPPORT, CPC 508.2,

A2 COMPARTMENTS WITHIN AN UNCONFINED, AREA OF A BUILDING SHALL HAVE AT LEAST TWO OPENINGS LOCATED WITHIN THE UPPER AND LOWER 12" OF THE ENCLOSURE FOR COMBUSTION AIR. EACH OPENING SHALL HAVE A MINIMUM DIMENSION OF 3" AND AN AREA OF AT LEAST 100 SQ, IN. OPENING SHALL HAVE A MINIMUM DIMENSION OF 3" AND AN AREA OF AT LEAST 100 SQ, IN.

A3 COMPARTMENTS WITHIN AN <u>CONFINED</u> AREA OR LOCATED IN THE BASEMENTS OR UTILITY OFFINESS LOCATED WITHIN THE UPPER AND LOWER 12' OF THE ENCLOSURE FOR COMBISSITION ARE AGEN OF PORTING SHALL HAVE A REAGE OF A LESST 18 L. N. PER 4000 BTUHR INPUT AND MIST SET FREELY COMMANDATING WITH THE OUTDOORS, OCH 507A.

A.4 COMPARTMENT DOOR SHALL BE LARGE ENOUGH TO PROVIDE FOR REMOVAL OF WATER HEATER.

B. WATER HEATER, FURNACE OR OTHER HEAT-PRODUCING APPLIANCES LOCATED IN GARAGE, WHICH CREATE A GLOW OR SPAIR, MUST BE LOCATED A MINIMUM OF 16' ABOVET THE GARAGE FLOOR AND SHALL BE PROTECTED FROM AUTOMOBILE DAMAGE, PROVIDE PLATFORM DETAILS PROTECTION BARRIERS (WHEEL BLOCKS ANE NOT ACCEPTABLE) OR RELOCATE FROM PATH OF VEHICLE. CIVE 50', TAND DOE 50', TO

C. ALL EXTERIOR OUTLETS WILL BE PROVIDED WITH GFI PROTECTION PER CEC ARTICLE 210,8(A)

ENERGY REQUIREMENTS

A, "PERMANENT LIGHTING SHALL COMPLY WITH THE MANDATORY MEASURES LISTED ON FORMS MF-1R ATTACHED", (SEE SHEET # 8 ACCORDINGLY)

ALL EXTERIOR/ OUTDOOR LIGHTING SHOULD BE HIGH EFFICACY LIGHTING.

ALL FENESTRATIONS ON WINDOWS AND DOORS SHALL HAVE U-FACTORS AND SOLAR HEAT GAIN COEFFICIENT (SHGC) VALUES IN ACCORDANCE WITH T-24 ENERGY CALCULATIONS.
ALL FENESTRATION MUST HAVE TEMPORARY AND PERMANENT LABELS.

ROOMS CONTAINING BATHTUBS, SHOWERS, SPAS AND SIMILAR FIXTURES SHALL BE PROVIDED WITH AN EXHAUST FAN 4.506.1, CBC 1203.4.3.2.1, CMC T-4-4)

4. PLUMBING FIXTURES.
a. NEW CONSTRUCTION (CG 4.383.); COMPLY WITH CAL GREEN MANDATORY REQUIREMENTS.
b. ADDITION & ALTERATION (CPC 402.16 4.02.2);
| SHOWERSHEADS: mastures 12 gpm @ 80 pcl
| LAVATORY FALOETS: mastures 15 gpm @ 80 pcl
| WATER LOSE: mastures 15 gpm @ 80 pcl
| WATER LOSE: mastures 16 gpm @ 80 pcl
| WATER LOSE: mastures 16 gpm @ 80 pcl
| WITCHEN FAUCET: mastures 16 gpm @ 80 pcl
| WITCHEN FAUCET: mastures 16 gpm @ 80 pcl
| WITCHEN FAUCET: mastures 16 gpm @ 80 pcl
| WITCHEN FAUCET: mastures 16 gpm @ 80 pcl
| WITCHEN FAUCET: mastures 16 gpm @ 80 pcl
| WITCHEN FAUCET: mastures 16 gpm @ 80 pcl
| WITCHEN FAUCET: mastures 16 gpm @ 80 pcl
| WITCHEN FAUCET: Mastures 16 gpm @ 80 pcl
| WITCHEN FAUCET: Mastures 16 gpm @ 80 pcl
| WITCHEN FAUCET:

CLEARANCE FOR WATER CLOSET TO BE A MINIMUM OF 24 INCHES IN FRONT, AND 15 INCHES FROM IT'S CENTE TO ANY SIDE WALL OR OBSTRUCTION. CPC 407.5

8... THE WATER HEATER BURNER TO BE ATLEAST 18 INCHES ABOVE THE GARAGE FLOOR, IF LOCATED IN GARAGE INSTALL 3 INCH DIAMETER BY 3FT TALL STEEL PIPE EMBEDDED IN CONCRETE SLAB FOR PROTECTION OF WATER HEATERS LOCATED IN GARAGE, CPC 508,14

8. WATER HEATERS TO BE STRAPPED AT TOP AND BOTTOM WITH 1 1/2" X 16 GAUGE STRAP WITH 3/6" DIA. X 3" LAG BOLT EACH END, CPC 508 2

THE CLOTHES DRYER VENT SHALL NOT EXCEED 14 FT IN OVERALL LENGTH WITH MAXIMUM TWO 90 DEGREE ELBOWS. (CMC 504.3.2.)

ROOFTOPS, OUTDOOR OUTLETS, WITH 6' OF WETBAR SINK / LAUNDRY SINK TO BE PROTECTED BY GROUND FAULT CIRCUIT INTERRUPTER (GFCI). (CEC 210.0)

11, ALL 120V SINGLE PHASE, 15 AND 20 AMP OUTLETS (RECEPTACLE, LIGHTING, SMOKE DETECTORS ETC.)
TO BE PROTECTED BY COMBINATION TYPE ARC-FAULT CIRCUIT INTERRUPTER (AFCI). (CEC 210.12)

UTILITY PLANS SCALE:

ELECTRICAL, TELEPHONE & PLUMBING NOTES:

4. ALL OUTLETS ARE 10 BE GROUND TYPE.

5. SWITCHES TO BE AT 42" ABOVE FLOOR.

₩ 1 2 WALL HUNG

G

FIRST FLOOR PLAN

T BOY ME

ELECT, METER

GAS METER

1. ALL WORK TO CONFORM TO THE 2013 CEC UNLESS NOTED OTHERWISE

A) ALL RECEPTACLES INSTALLED IN A BATHROOM [216-8(A)(1)]
8) ALL RECEPTACLES INSTALLED IN A GARAGE [216-8(A)(1)]
C) ALL OUTDOOR RECEPTACLE;
C) AT LEAST ONE RECEPTACLE IN A BASEMENT [210-8(A)(S)]
E) ALL RECEPTACLES IN THE NOTOHEN [210-8(A)(S)]
IN LAUNDRY ROOM.

MIN. 4" DIA. -1 EXCEED 14 ER.

ELECTRICAL OUTLETS TO BE SPACED AT 12'0' MAXIMUM ALONG WALLS INCLUDING SLIDING GLASS DOORS AT EXTERIOR WALLS AND ANY WALL SPACE 2 FT, (610 MM) OR MORE, (NEC 210-52)

3 ISLAND AND PENINSULA COUNTER TOPS SHALL HAVE AT LEAST ONE ELECTRICAL RECEPTACLE FOR EACH FOUR FEET OF COUNTER TOP.

6. GROUND-FAULT CIRCUIT-INTERRUPTER (GFCI) PROTECTED ELECTRICAL RECEPTACLES SHALL BE

ELECTRICAL RECEPTACLES INSTALLED OUTDOORS WHERE EXPOSED TO WEATHER SHALL BE IN A WEATHERPROOF ENCLOSURE, (NEC 410-57)

8. PROVIDE FLORESCENT GENERAL LIGHTING (40 LUMENS PER WATT MINIMUM) IN KITCHEN(S)

VERIFY WITH OWNER REGARDING MULTI-MEDIA HOME AUTOMATION SYSTEM WITH WIRING STATIONS FOR INTERCOM, COMPUTERS AND TELECOMMUNICATIONS.

NOTE TO ELECTRICAL CONTRACTORS: DURING FRAMING THE GENERAL CONTRACTOR AND THE DESIGNER WILL DO A WALK THROUGH TO VERIFY THE FINAL ELECTRICAL DESIGN.

SECOND FLOOR PLAN

10. NOTE TO ELECTRICAL CONTRACTORS: DURING FRAMING THE GENERAL CONTRACTOR AND THE DESIGNER WILL DO A WALK THROUGH TO VERIFY THE FINAL ELECTRICAL DESIGN.

11. VERIFY ALL ELECTRICAL REQUIREMENTS WITH MANUFACTURER'S SPECIFICATIONS 12. LOCATE ALL PLUMBING AND HEATING VENTS TO THE REAR OF THE BUILDING.

13. PROVIDE AN APPROVED VENT CAP FOR THE FURNACE VENT OR TERMINATE THE VENT 2' ABOVE THE ROOF PER UMC SECTION 805.4

ALL SHOWERS AND TUB-SHOWERS SHALL HAVE EITHER A PRESSURE BALANCE OR A THERMOSTATIC MIXING VALVE. (P.C. 420)

ALL PLUMBING MATERIALS, EQUIPMENT, AND INSTALLATION SHALL BE DONE IN ACCORDANCE WITH THE 2013 CALIFORNIA PLUMBING CODE.

NEW OR REPLACEMENT WATER HEATERS SHALL BE STRAPPED FOR LATERAL SUPPORT WITH 2-2" X 18 GA. SEISMIC STRAP, STRAP IN TWO LOCATIONS: ONE IN THE UPPER 13: 0F THE TANK AND THE LOWER POINT SHALL BE A MINIMUM 4 INCHES ABOVE THE CONTROLS, (P.C., 510.5)

GAS FIRED WATER HEATER TO BE PROVIDED WITH 100-SQ, IN, COMBUSTION AIR OPENING WITHIN 12° OF CEILING AND 100 SQ, IN WITHIN 12° OF FLOOR, (PC TABLE 5-1 AND MC TABLE 7-A)

PROVIDE INSPECTION AND REPAIR ACCESS FOR FIXTURES HAVING SUP JOINT CONNECTIONS
OTHERWISE JOINTS SHALL HAVE A SOLID CONNECTION (SOLDERED, SCREWED, OR SOLVENT-CEMENTED). (P.C. 405.2)

PROVIDE CLEARANCES OF 30 INCH (762 MM) CLEAR WIDTH AND 24 INCH (610 MM) IN FRONT OF WATER CLOSETS. (2904)

21. ALL TELEPHONE LINES MUST HAVE SUFFICIENT WIRING FOR (3) THREE TELEPHONE LINES,

FOR WET / DAMP LOCATION

(a)

ACCESS

20. PROVIDE A TEMPERATURE AND PRESSURE RELIEF VALVE AT THE WATER HEATER. (PC 608.5, 605.3,

08 - 04 - 17 PN 3343 - G

These desi Draffing & publication prohibited approval or

td.

sign,

0

Ø

J

با

⋖

≥

000

BUILDING

ARWATER

Ш

TORY HOME

2-S NEW :

C 286 N

2303

915

(626)


SHEET NO.

PLANT LEGEND

SYM. BOTANICAL NAME	COMMON NAME	PLANT FACTOR	SIZE	H x W
Lagerstromia Indica	Crape Myrtle	М	24" box	
Geljera parviflora	Australian Willow	Ĺ	24" box	
SHRUB				
Anigozanthos 'Big Red'	Red Kangaroo Paw	М	5 gal	18" x 18"
Carex divulsa	Berkeley Sedge	М	1 gal	12" x 12"
Agave desmittana	Dwarf Agave	М	5 gal	2.5' x2.5'
Echlum fastuosum	Pride of Maldera	М	5 gai	5' x 5'
O Dodonea viscosa 'Purpurea'	Purple Hopseed Bush	L	15 gal	15' x 10'
Helictotrichon sempervirens	Blue Oat Grass	М	1 gal	2.5' x 2.5'
Muhlenbergia rigens	Deer Grass	ŀ	5 gal	30" x 30"
Senecio mandraliscae	Senecio	M	1 gal	12" x 12"
Echeveria Afterglow	NCN	М	1 gal	2' x 2'
C3 Lantana montevidensis	Trailing Lantana (yellow)	L	5 gal	12" x 12"
* Pensternon spp.	Penstemon	М	1 gal	24" x 24"
Cynodon dactylon	Bermuda Grass	L	SOD	

PLANTING NOTES

- 1. CONTRACTOR SHALL NOTIFY THE LANDSCAPE ARCHITECT OF SITE CONDITIONS WHICH PREVENT INSTALLATION PER PLANS AND SPECIFICATIONS.
- 2. CONTRACTOR SHALL BE LIABLE FOR REMOVING AND REINSTALLING IRRIGATION EQUIPMENT, AND REPLANTING AREAS WHICH ARE NOT INSTALLED PER PLAN AND SPECIFICATIONS.
- 3. IRRIGATION SYSTEM SHALL BE INSTALLED AND OPERATING PRIOR TO PLANT MATERIALS.
- 4. TREES AND SHRUBS SHALL BE PLANTED AFTER CONCRETE PLACEMENT, BUT NOT BEFORE IRRIGATION COVERAGE TEST NO. 1 HAS BEEN APPROVED. (SEE SPECIFICATIONS).
- 5. PLACE TREES BETWEEN IRRIGATION HEADS WHEREVER POSSIBLE.
- 6. SHREDDED MULCH INSTALLATION: INSTALL SHREDDED MULCH IN ALL SHRUB AND GROUNDCOVER AREAS PER SPECIFICATIONS, UNLESS OTHERWISE INDICATED ON PLANS.
- 7. CONTRACTOR IS RESPONSIBLE FOR ALL REPAIRS AND/OR REPLACEMENT OF ANY DAMAGED LANDSCAPE AREAS BEYOND THE LIMIT OF WORK, THAT IS A DIRECT RESULT OF THE LANDSCAPE CONSTRUCTION AND/OR HIS SUB-CONTRACTOR. REPLACEMENT ITEMS SHALL BE EXACT DUPLICATE OF ORIGINAL WORK OR PLANS, UNLESS OTHERWISE APPROVED BY THE LANDSCAPE ARCHITECT.
- 8. WHEREVER GROUNDCOVER AREAS ARE ADJACENT TO TURF INSTALL CONCRETE MOWSTRIP OR HEADERBOARD AS INDICATED ON DRAWINGS.
- 9. CLEAN-UP SHALL TAKE PLACE ON A DAILY BASIS UNLESS OTHERWISE APPROVED BY THE OWNER'S REPRESENTATIVE.

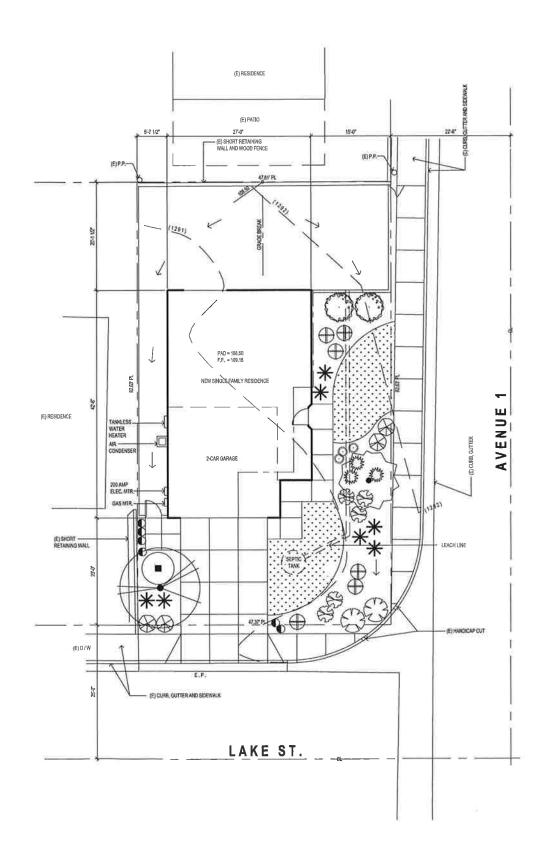



REVISIONS BY

GE Landscape

NEW 2-STORY HOME LAKE STREET LAKE EISHORE, CA 92530 PLANTING PLAN



ORAWN **RE** CHECKED 12/11/2017 1/8"=1"-8" 207-17